
# CONSTRUCTION PLANS FOR EAST SIDE UNION HIGH SCHOOL DISTRICT 2017 TRANSPORTATION YARD RELOCATION PROJECT



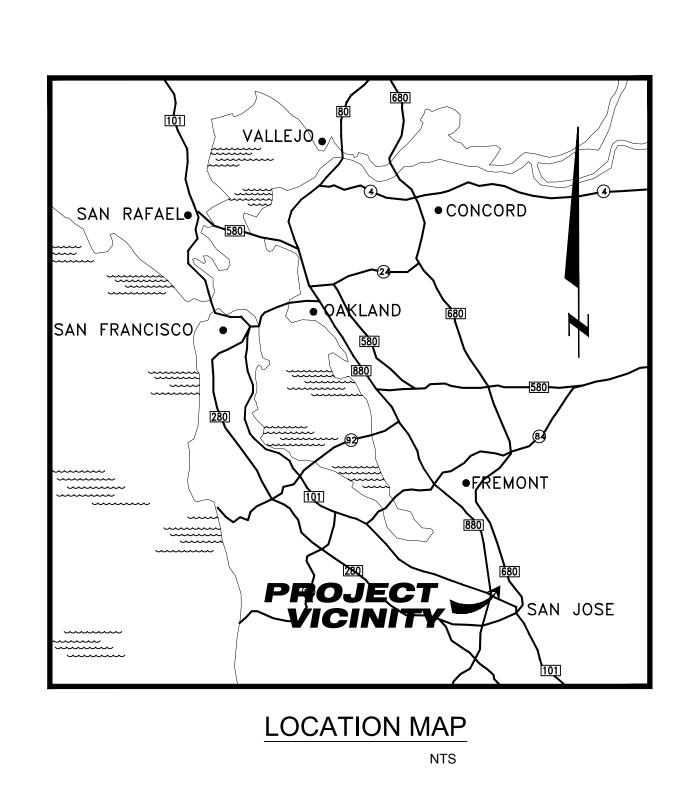


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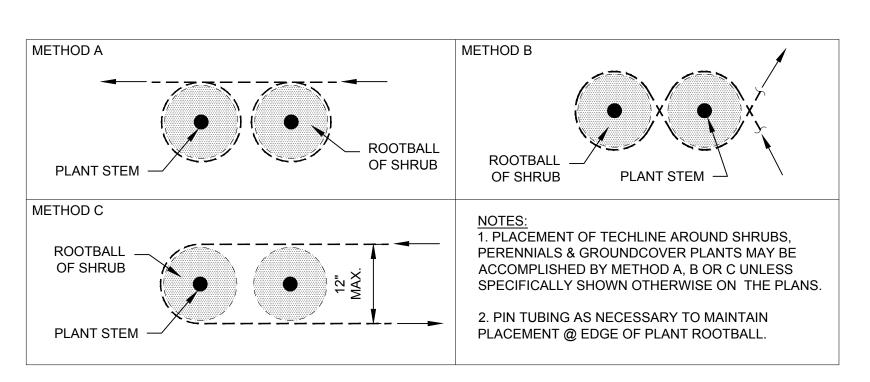
PROJECT ENGINEER: WILLIAM J. LONG						
LICENSE: CA 047552 EXP.: 12-31-17						
PLAN S	PLAN STATUS:					
FINAL	PLANS					

FOR CONSTRUCTION




taluma Office	(707) 769-5330
edding Office	(530) 224-4535
n Luis Obispo Office	(805) 781-2265

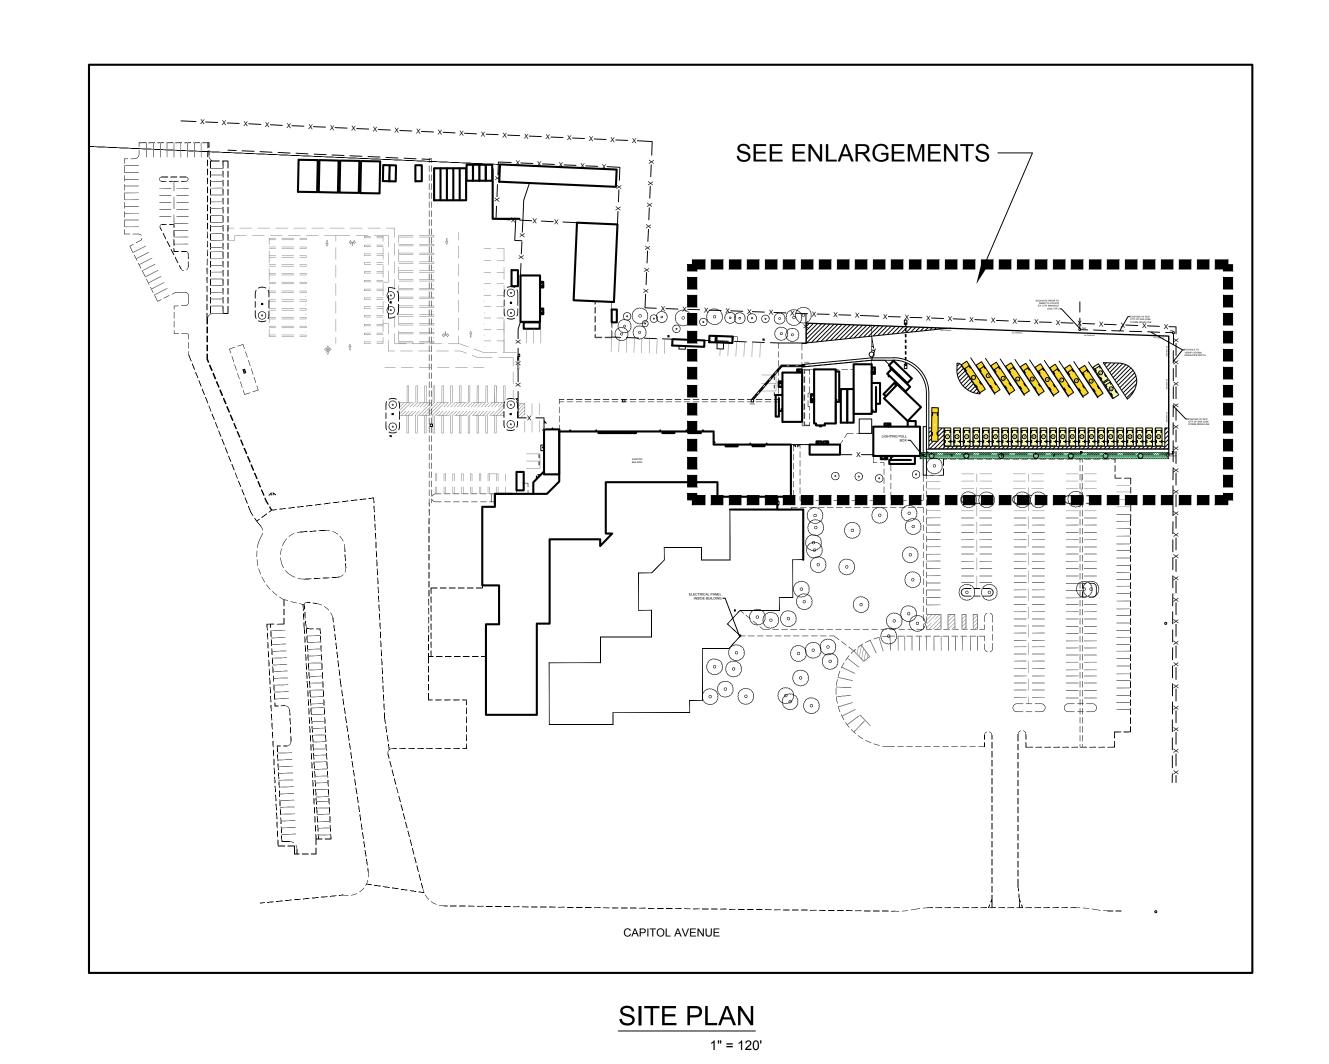
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ıc.		T SIDE UN NORTH C	RICT SAN JOSE,	CA	
	SCALE:	AS SHOWN	APPROVED BY:	DRAWN BY:	BTR
1	DATE:	JAN. 2017		REVISED:	
	201	7 TRANSP	ORTATION YARD RELOCATI TITLE PAGE	ON PROJEC	Т
	EAST	SIDE UNIC	ON HIGH SCHOOL DISTRICT	drawing number 160290-01	C1




## TECHLINE PLACEMENT: SINGLE LOOP

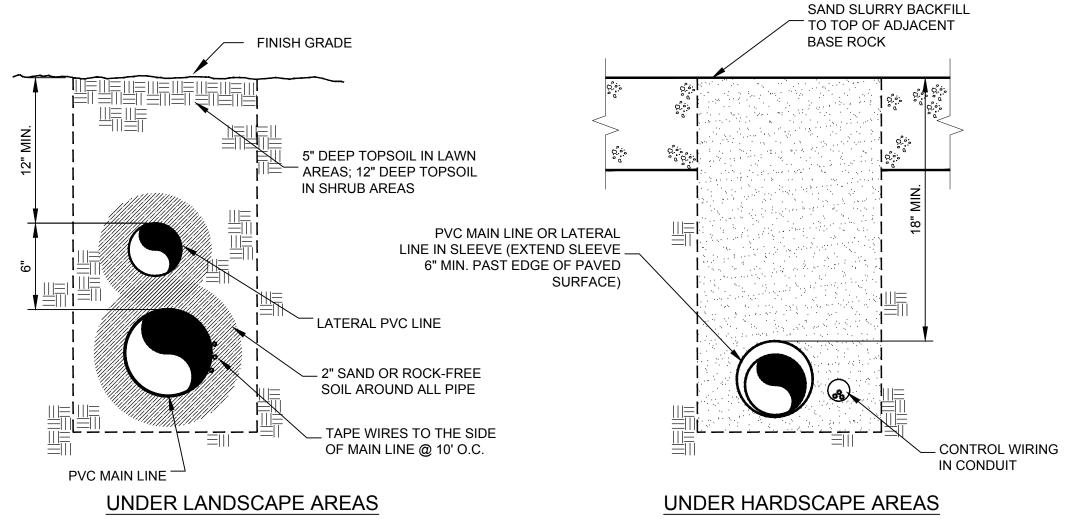


# TRENCH SECTION DETAIL

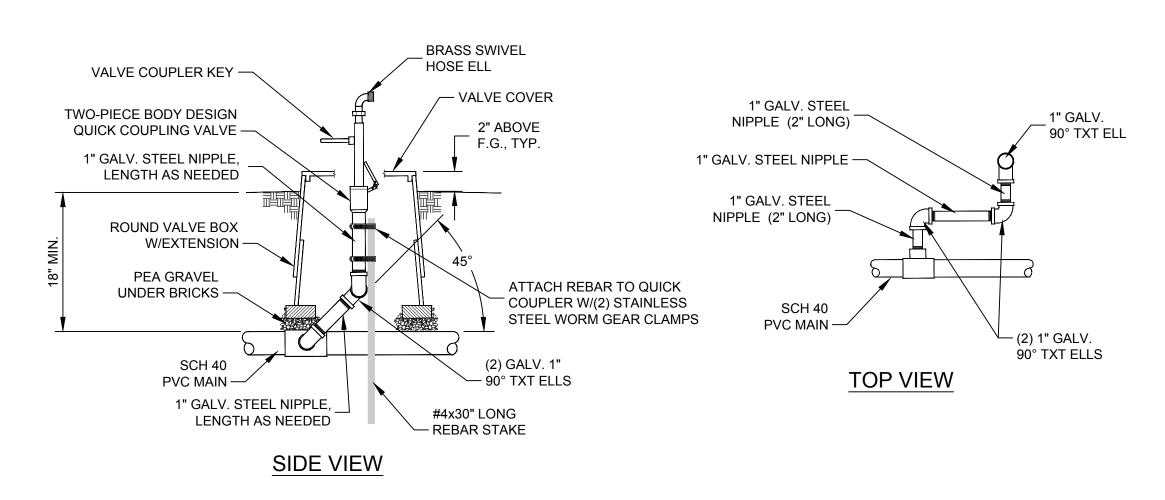


QUICK COUPLING VALVE DETAIL

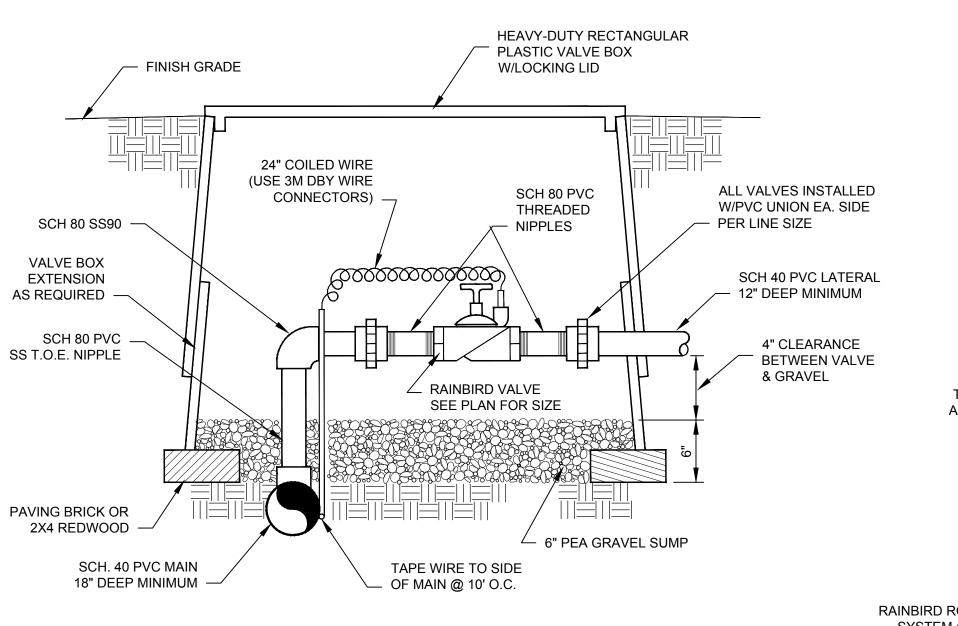


# AUTOMATIC CONTROL VALVE DETAIL

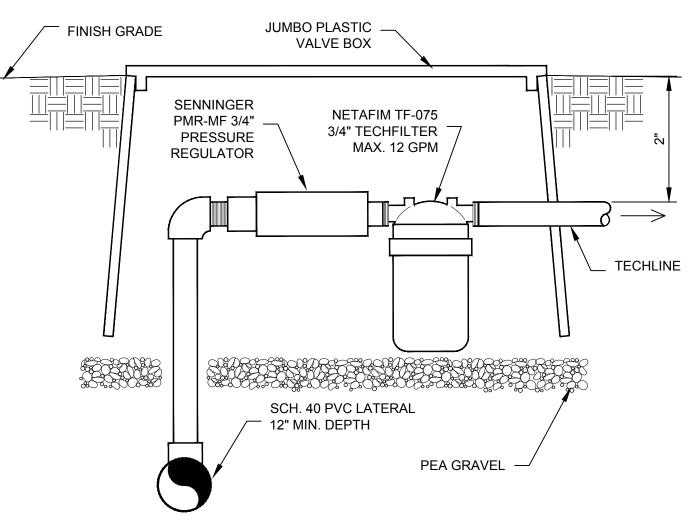

# NETAFIM CONNECTION DETAIL NTS

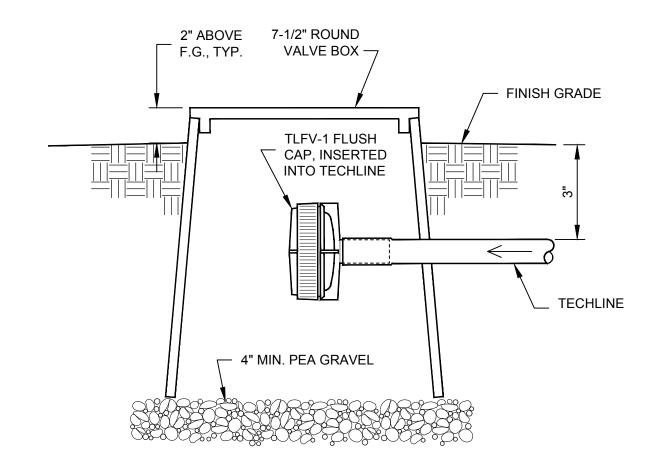

NETAFIM FLUSHING CAP DETAIL

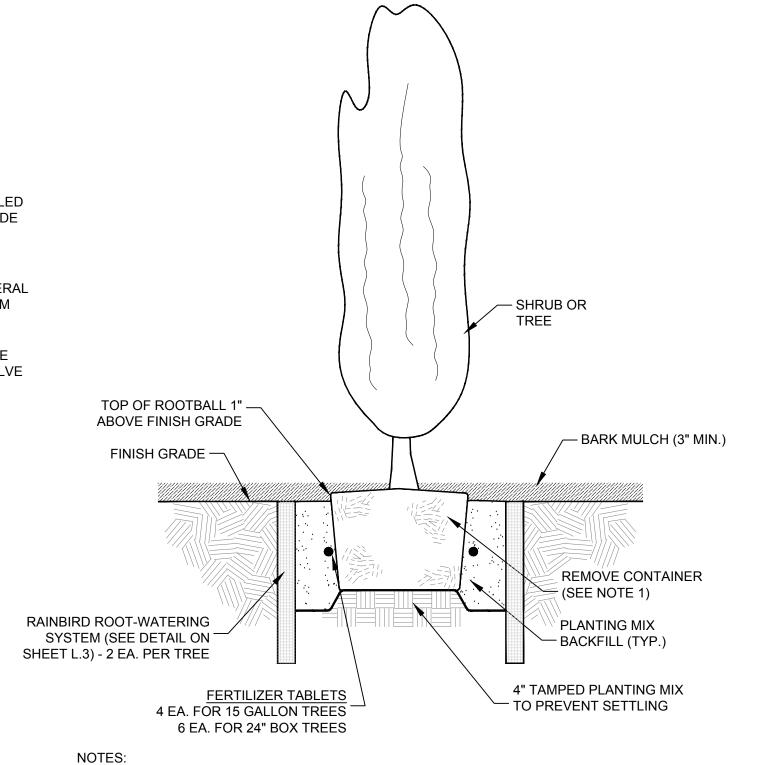


NOTES:
IF SHRUB OR TREE IS BOXED, REMOVE BOX BOTTOM PRIOR TO POSITIONING IN HOLE, AND REMAINDER OF BOX PRIOR TO BACKFILL. IF PLANT IS BURLAPPED, REMOVE TOP 1/3 OF COVER. IF PLANT IS COVERED IN NON-BIODEGRADABLE MATERIAL, REMOVE COMPLETE COVERING PRIOR TO INSTALLATION. PROTECT ROOT BALL FROM DAMAGE DURING PLANTING & STAKING.

WATER THOROUGHLY SUBSEQUENT TO INSTALLATION.

REMOVE STAKES AND TIES (IF SPECIFIED) AT END OF GUARANTEE PERIOD.

# TYPICAL SHRUB OR TREE PLANTING DETAIL

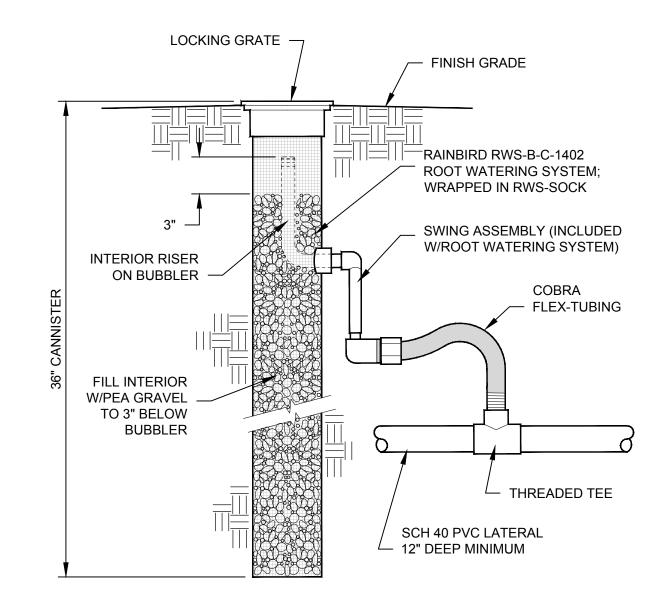

DEEP ROOT-WATERING SYSTEM

				ddv
				NOITGIGUSEU
				DATE
				/\⊐@
	· )			

Pavement Engineering Inc.

You can ride on our reputation
corporate Office:
3485 Sacramento Drive, Suite A
San Luis Obispo, CA 93401-6015
805-781-2265

SCHOOL DISTRICT
SAN JOSE, CA

TRANSPORTATION YARD RELOCATION LANDSCAPING DETAILS

EAST SIDE UNION HIGH
830 N. CAPITOL AVENUE
2017 TRANSPORTATION YARD

RAWN BY:

MPW

ROJECT NUMBER:

160290

CALE:


1"= 20'


ATE:

JAN. 2017

HEET NUMBER:

L3

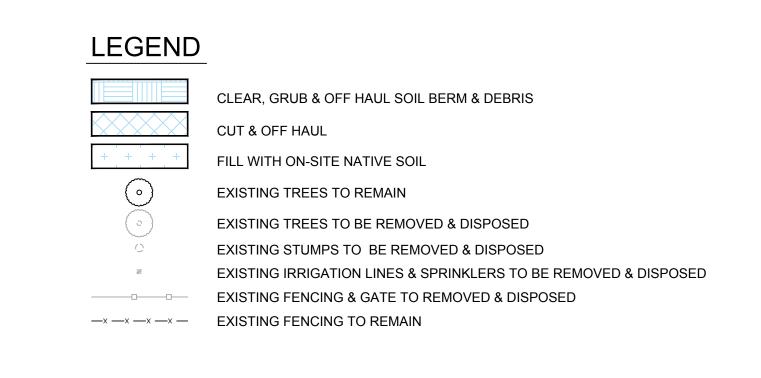

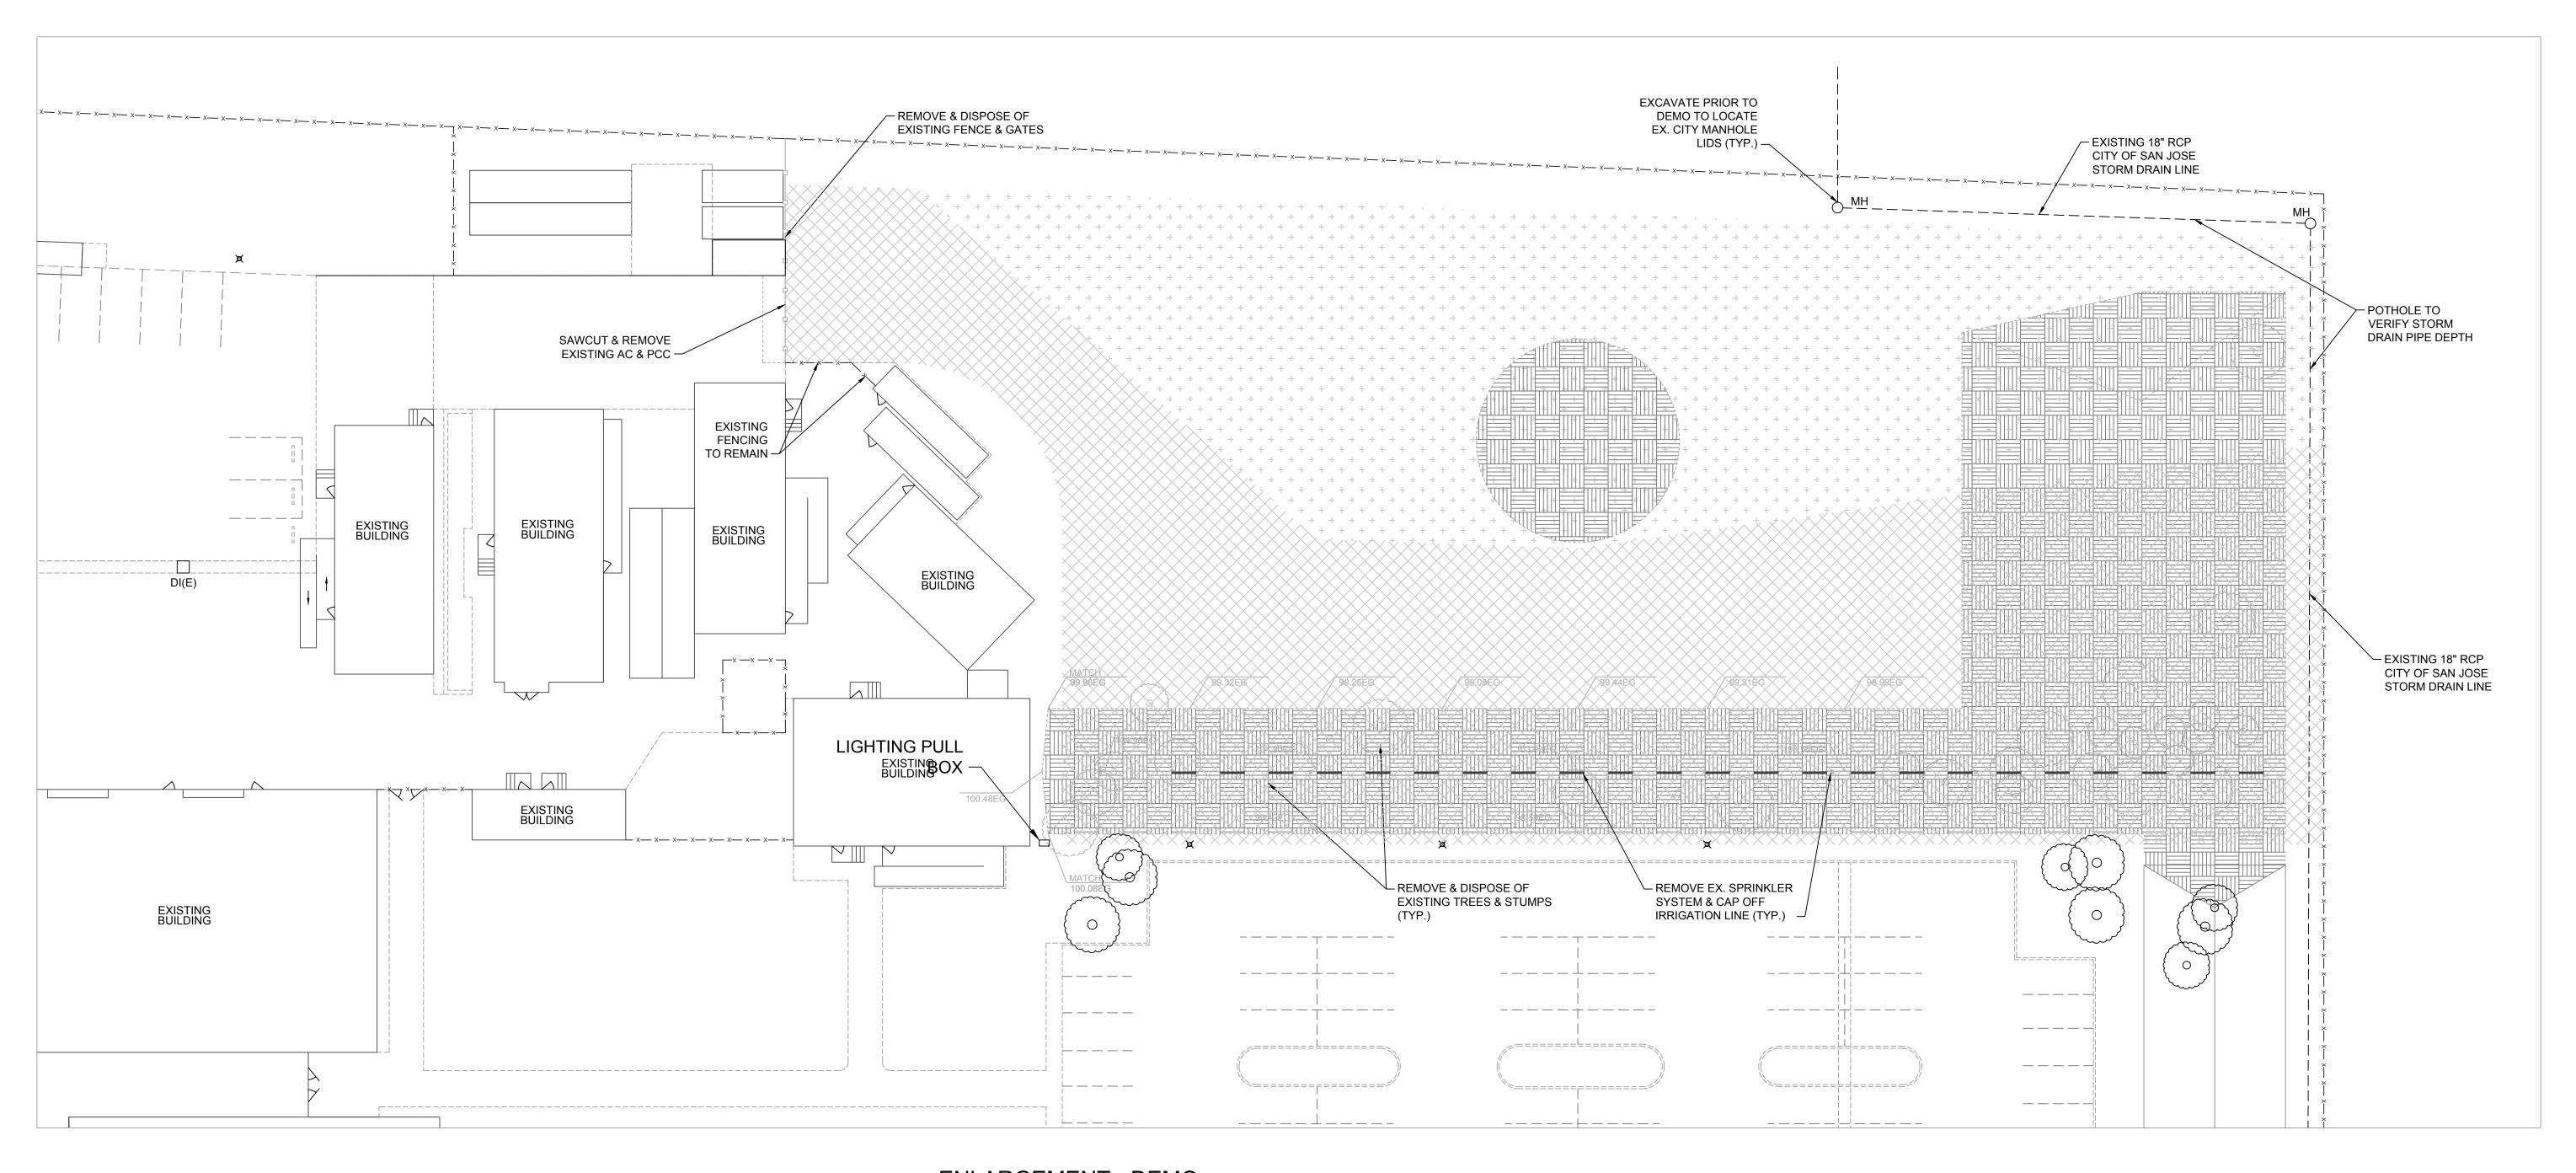

**ENLARGEMENT - DEMO** 

PROJECT ENGINEER: WILLIAM J. LONG LICENSE: CA 047552 EXP.: 12-31-17 PLAN STATUS: FINAL PLANS

FOR CONSTRUCTION

Pavement Engineering Inc.
Civil Engineers • Materials Testing Specializing in Pavement Rehabilitation

Redding Office


San Luis Obispo Office

DATE: JAN. 2017 (530) 224-4535

EAST SIDE UNION HIGH SCHOOL DISTRICT 830 NORTH CAPITOL AVENUE SAN JOSE, CA SCALE: 1" = 20' APPROVED BY: DRAWN BY: BTR 2017 TRANSPORTATION YARD RELOCATION PROJECT DEMO PLAN EAST SIDE UNION HIGH SCHOOL DISTRICT DRAWING NUMBER 160290-01

### NOTES:

- 1. CONTRACTOR SHALL BE RESPONSIBLE FOR ANY AND ALL TESTING THAT MAY BE REQUIRED TO LEGALLY DISPOSE OF EXCESS MATERIAL.
- 2. CONTRACTOR SHALL RESTRIPE ALL AREAS THAT ARE DISTURBED DURING CONSTRUCTION TO MATCH EXIST. STRIPING LAYOUTS.
- 3. ALL WORK SHALL BE PERFORMED IN ACCORDANCE WITH THE PLANS & CONTRACT DOCUMENTS. WORK NOT COMPLYING WITH PLANS & CONTRACT DOCUMENTS WILL BE SUBJECT TO REMOVAL AND REPLACEMENT AT THE CONTRACTORS EXPENSE.
- 4. THE CONTRACTOR SHALL REMOVE ALL CONSTRUCTION DEBRIS AND LEAVE WORK AREA CLEAN DAILY.
- 5. ALL MATERIALS AND WORKMANSHIP ARE SUBJECT TO REVIEW BY OWNER. ANY PORTION OF THE WORK DEFECTIVE SHALL BE REPLACED BY THE CONTRACTOR AS PART OF THIS CONTRACT AT NO ADDITIONAL COST TO THE OWNER.
- 6. ABSOLUTE ACCURACY OF DRAWING CAN NOT BE GUARANTEED. WHILE EVERY EFFORT HAS BEEN MADE TO COORDINATE THE LOCATION OF THE EXISTING EQUIPMENT, PIPING, ETC. IT IS THE RESPONSIBILITY OF THE CONTRACTOR TO COORDINATE THE EXACT REQUIREMENTS GOVERNED BY ACTUAL JOB CONDITIONS.
- 7. AREAS NOT IN SCOPE OF WORK DISTURBED DURING CONSTRUCTION SHALL BE RESTORED TO THE EXISTING CONDITION AT THE CONTRACTORS EXPENSE.
- 8. CONTRACTOR SHALL CLEAN OUT ALL DRAINAGE STRUCTURES, INCLUDING DROP INLETS, & SHALL FLUSH STORM DRAIN LINES PRIOR TO COMPLETION OF WORK TO ENSURE NO BLOCKAGES EXIST IN THE SYSTEM.
- 9. PROTECT EXISTING BUILDING STRUCTURES, AND ADJACENT FINISHED SURFACES DURING CONSTRUCTION. PATCH, REPAIR AND REFINISH AREAS DAMAGED OR IMPACTED BY WORK DURING THIS PROJECT TO MATCH ADJACENT UNDISTURBED AREAS. PATCHING, REPAIRING AND REFINISHING IS TO BE PERFORMED BY WORKMEN SKILLED IN THE TRADES INVOLVED.
- 10. CONTRACTOR SHALL HAVE LOCATING SERVICE VERIFY LOCATION OF ALL EXISTING UTILITIES PRIOR TO EXCAVATION. CONTRACTOR SHALL CONTACT THE ENGINEER TO REVIEW AND ADDRESS ANY UTILITIES CONFLICTING WITH THE SCOPE OF WORK.
- 11. UTILITY BOXES IN CONSTRUCTION AREAS SHALL BE REUSED AND RAISED TO FINISHED GRADE. IF BOXES ARE NOT REUSABLE, CONTRACTOR SHALL NOTIFY ENGINEER PRIOR TO REMOVAL.
- 12. ALL AREAS OF PCC CHIPPED OR DAMAGED DURING CONSTRUCTION SHALL BE REMOVED AND REPLACED BACK TO THE NEXT JOINT.
- 13. SOILS WITHING LIMITS OF NEW BIOSWALE SHALL NOT BE CONTAMINATED WITH THE LIME TREATMENT PROCESS. CONTRACTOR SHALL COORDINATE WITH OWNER'S REPRESENTATIVE TO TEST FOR LIME IN PLANTER AREAS PRIOR TO COMMENCING LANDSCAPING WORK.

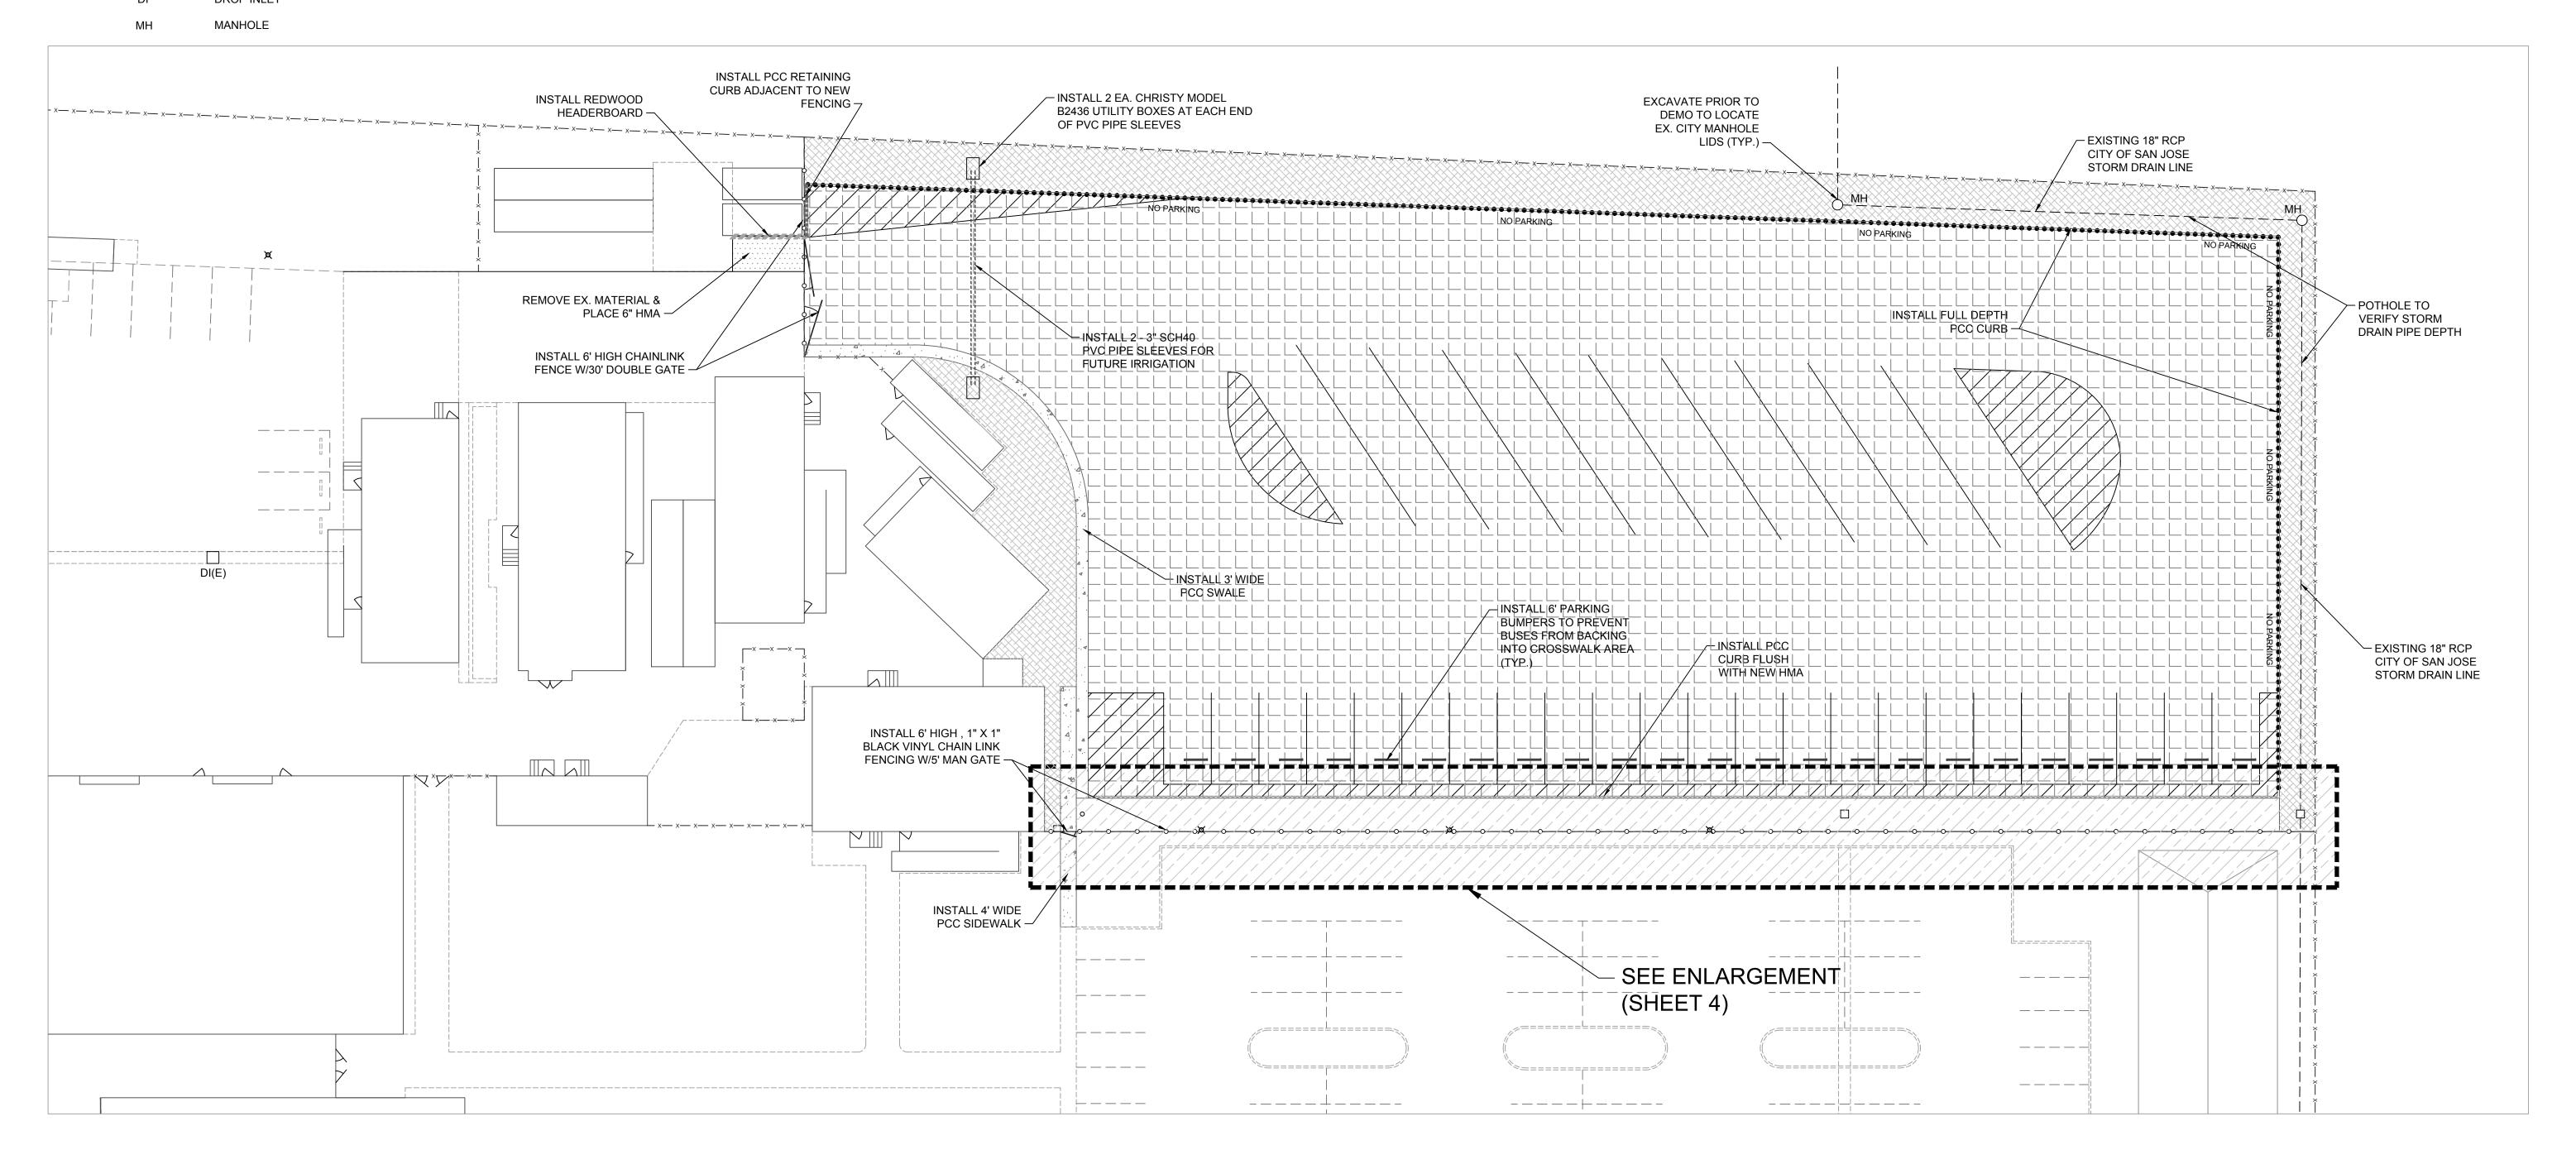

**ENLARGEMENT - PARKING AREA DESIGN** 

1" =

PROJECT ENGINEER: WILLIAM J. LONG

LICENSE: CA 047552 EXP.: 12-31-17

PLAN STATUS:

FINAL PLANS

FOR CONSTRUCTION

Pavement Engineering Inc.
Civil Engineers • Materials Testing
Specializing in Pavement Rehabilitation

Redding Office

San Luis Obispo Office

(530) 224-4535

EAST SIDE UNION HIGH SCHOOL DISTRICT
830 NORTH CAPITOL AVENUE

SAN JOSE, CA


SCALE: 1" = 20' APPROVED BY: DRAWN BY: BTR

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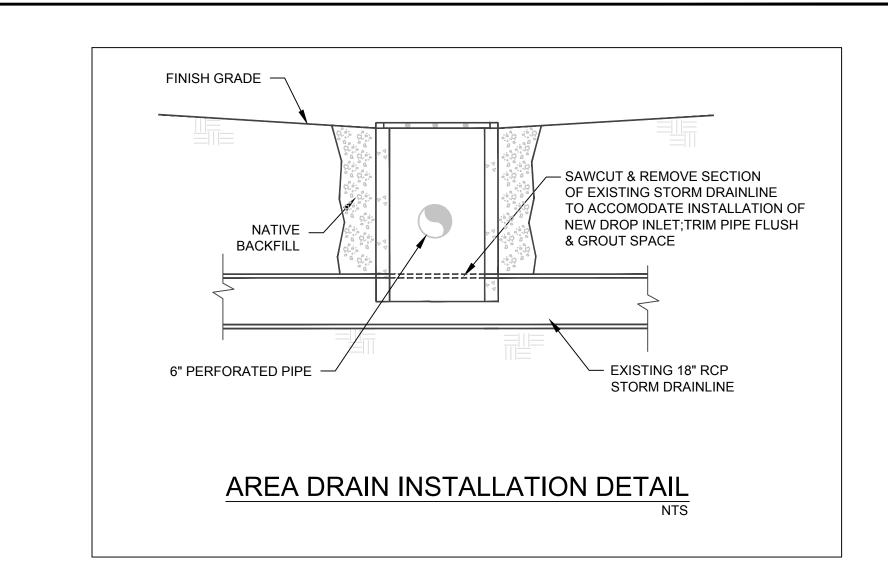
2017 TRANSPORTATION YARD RELOCATION PROJECT
DESIGN PLAN - PARKING AREA


EAST SIDE UNION HIGH SCHOOL DISTRICT


C3

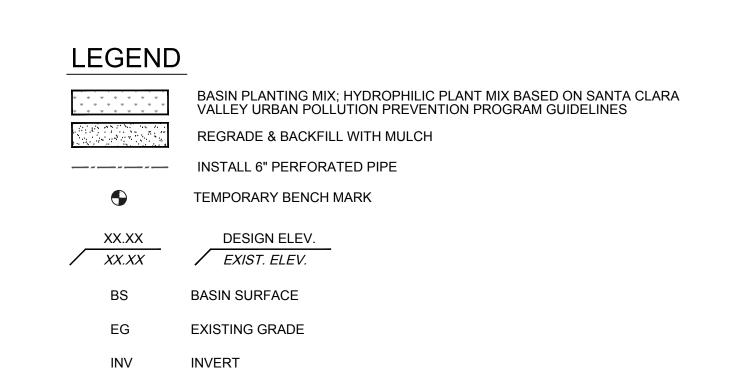


TOP OF GRATE



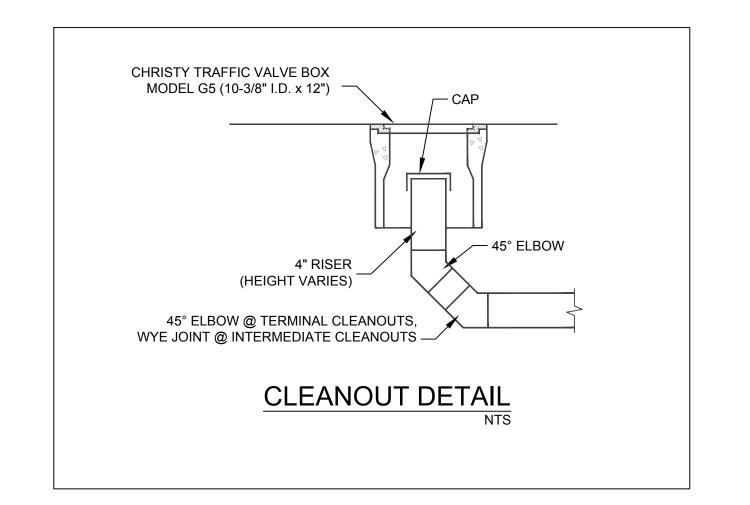

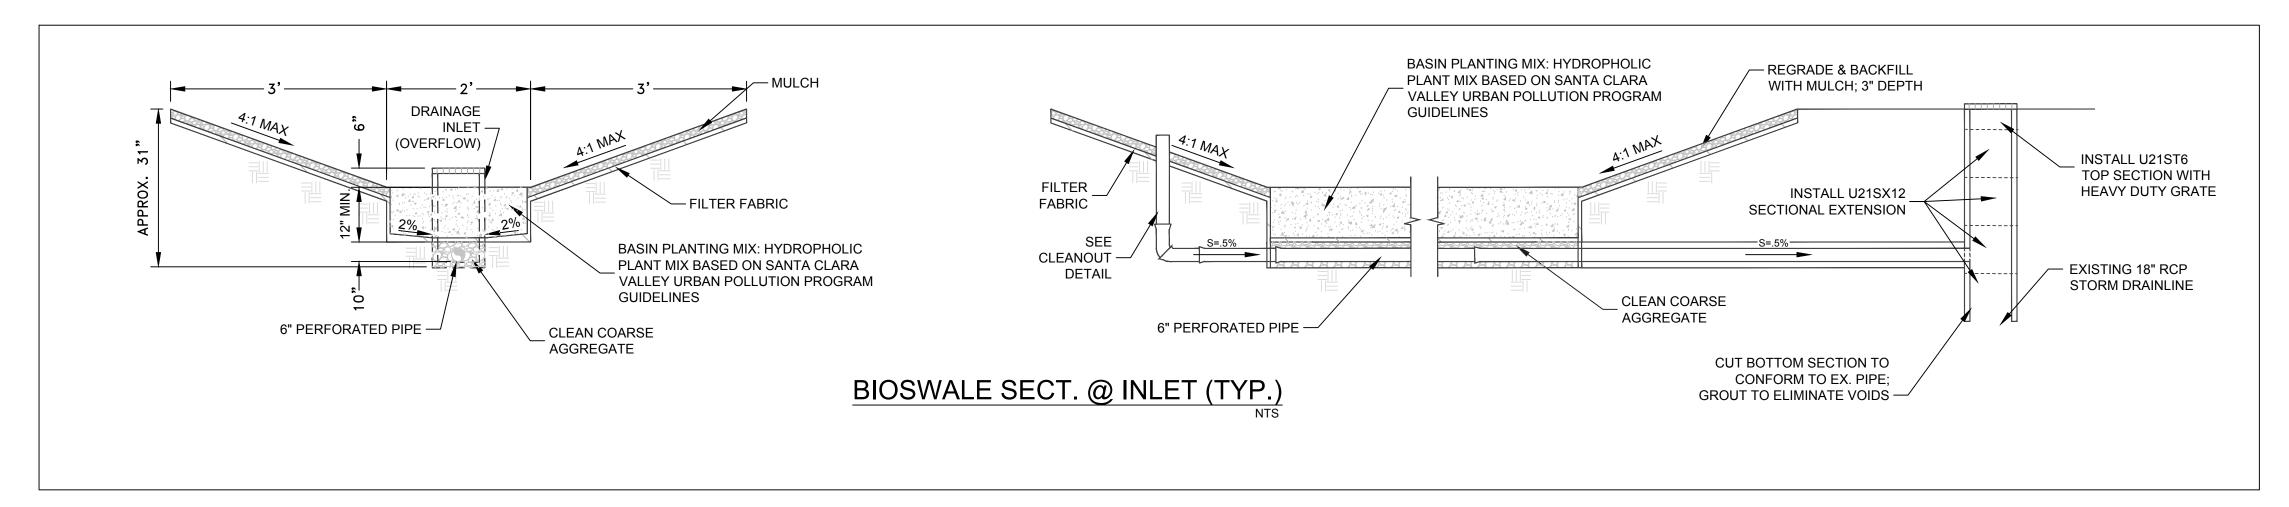

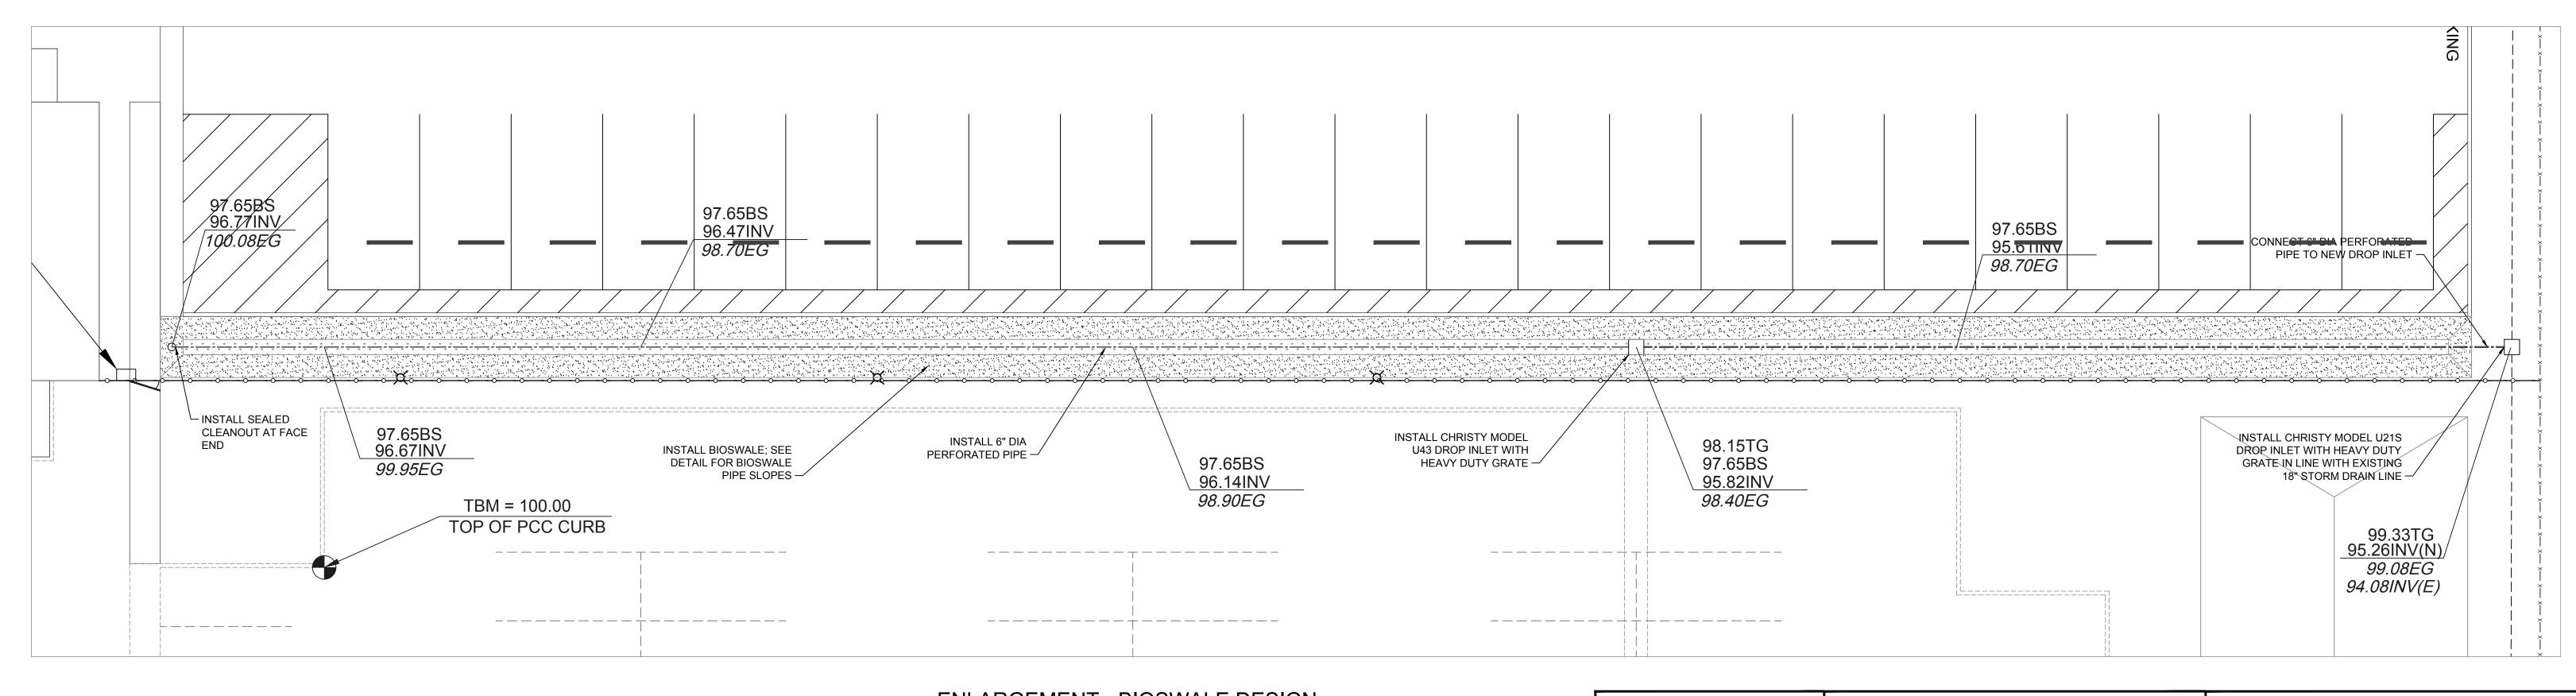

ENLARGEMENT - BIOSWALE DESIGN

1" = 10'

PROJECT ENGINEER: WILLIAM J. LONG

LICENSE: CA 047552 EXP.: 12-31-17

PLAN STATUS:

FINAL PLANS

FOR CONSTRUCTION

Pavement Engineering Inc.
Civil Engineers • Materials Testing
Specializing in Pavement Rehabilitation

EAST SIDE UNION HIGH SCHOOL DISTRICT
830 NORTH CAPITOL AVENUE

SCALE: 1" = 10' APPROVED BY: DRAWN BY: BTR

DATE: JAN. 2017

2017 TRANSPORTATION YARD RELOCATION PROJECT
DESIGN PLAN - BIOSWALE

EAST SIDE UNION HIGH SCHOOL DISTRICT

DRAWING NUMBER 160290-01 C4

Redding Office San Luis Obispo Office (530) 224-4535 (805) 781-2265

: Z:\Shared\R Drive\Acti

ricis. Path: Z:\Shared\R Drive\Active Projects\East Side UHSD\160 ◆ TEMPORARY BENCH MARK

XX.XX DESIGN ELEV.

XX.XX EXIST. ELEV.

EG EXISTING GRADE

EP EDGE OF PAVEMENT

FL FLOW LINE

LG LIP OF GUTTER


LTB LIME TREATED BASE

PCC PORTLAND CEMENT CONCRETE

SW SIDEWALK

TG TOP OF GRATE

TP TOP OF PAVEMENT

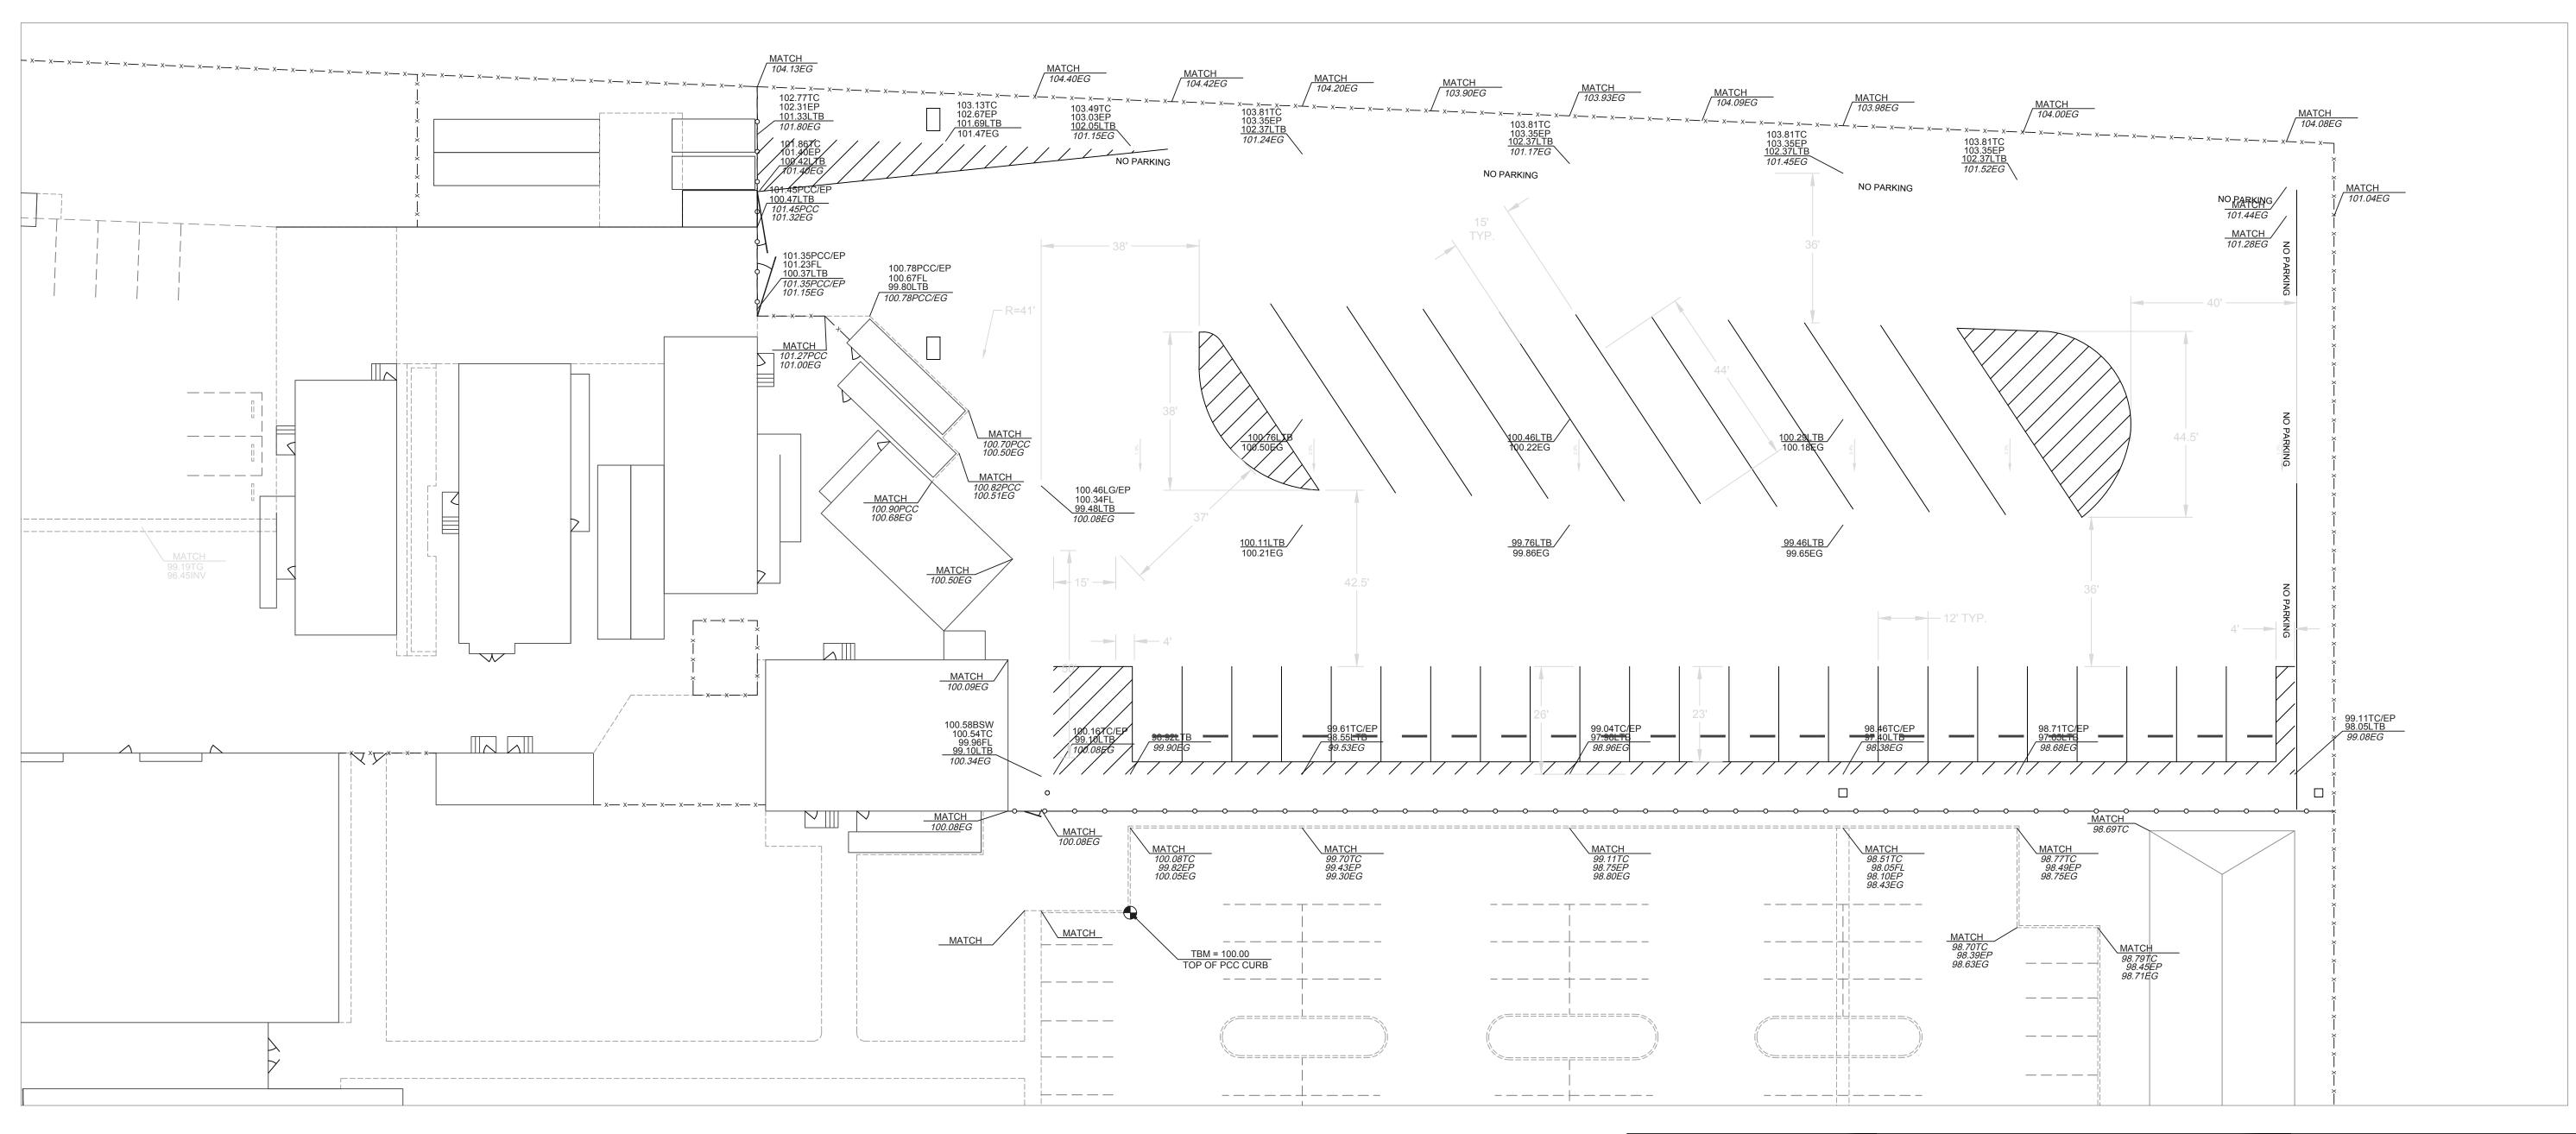

GRADING PLAN
1" = 20'

PROJECT ENGINEER: WILLIAM J. LONG

LICENSE: CA 047552 EXP.: 12-31-17

PLAN STATUS:

FINAL PLANS

FOR CONSTRUCTION

Pavement Engineering Inc.
Civil Engineers • Materials Testing
Specializing in Pavement Rehabilitation

Redding Office

San Luis Obispo Office

(707) 769-5330 (530) 224-4535 (805) 781-2265

EAST SIDE UNION HIGH SCHOOL DISTRICT
830 NORTH CAPITOL AVENUE

SCALE: 1" = 20' APPROVED BY: DRAWN BY: BTR

DATE: JAN. 2017


2017 TRANSPORTATION YARD RELOCATION PROJECT
GRADING/DIMENSION PLAN


EAST SIDE UNION HIGH SCHOOL DISTRICT


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160290-01


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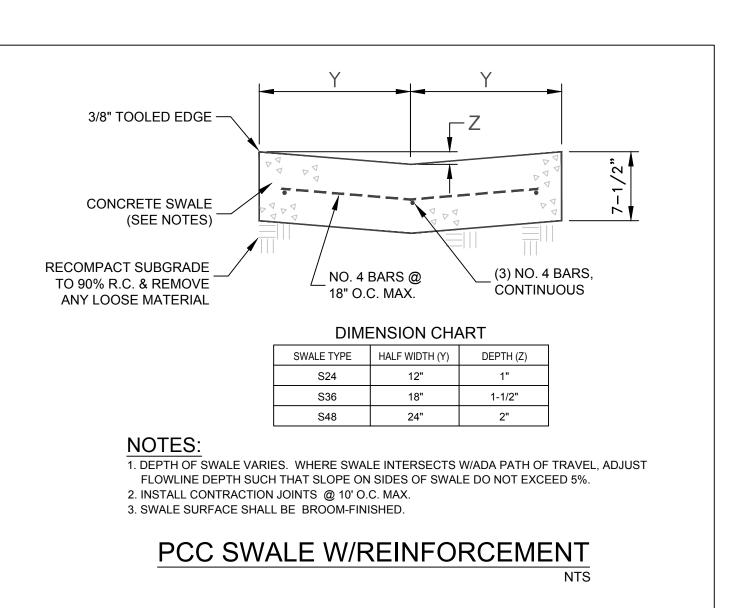
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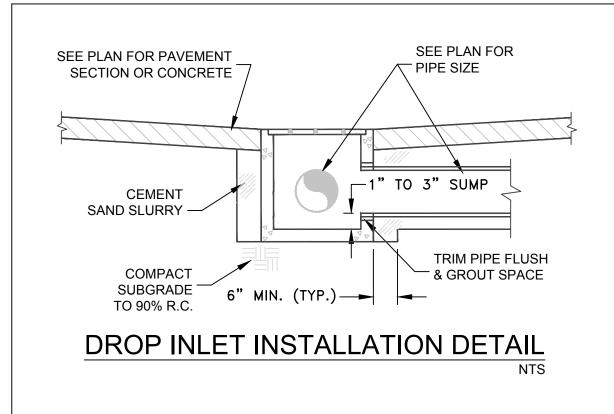





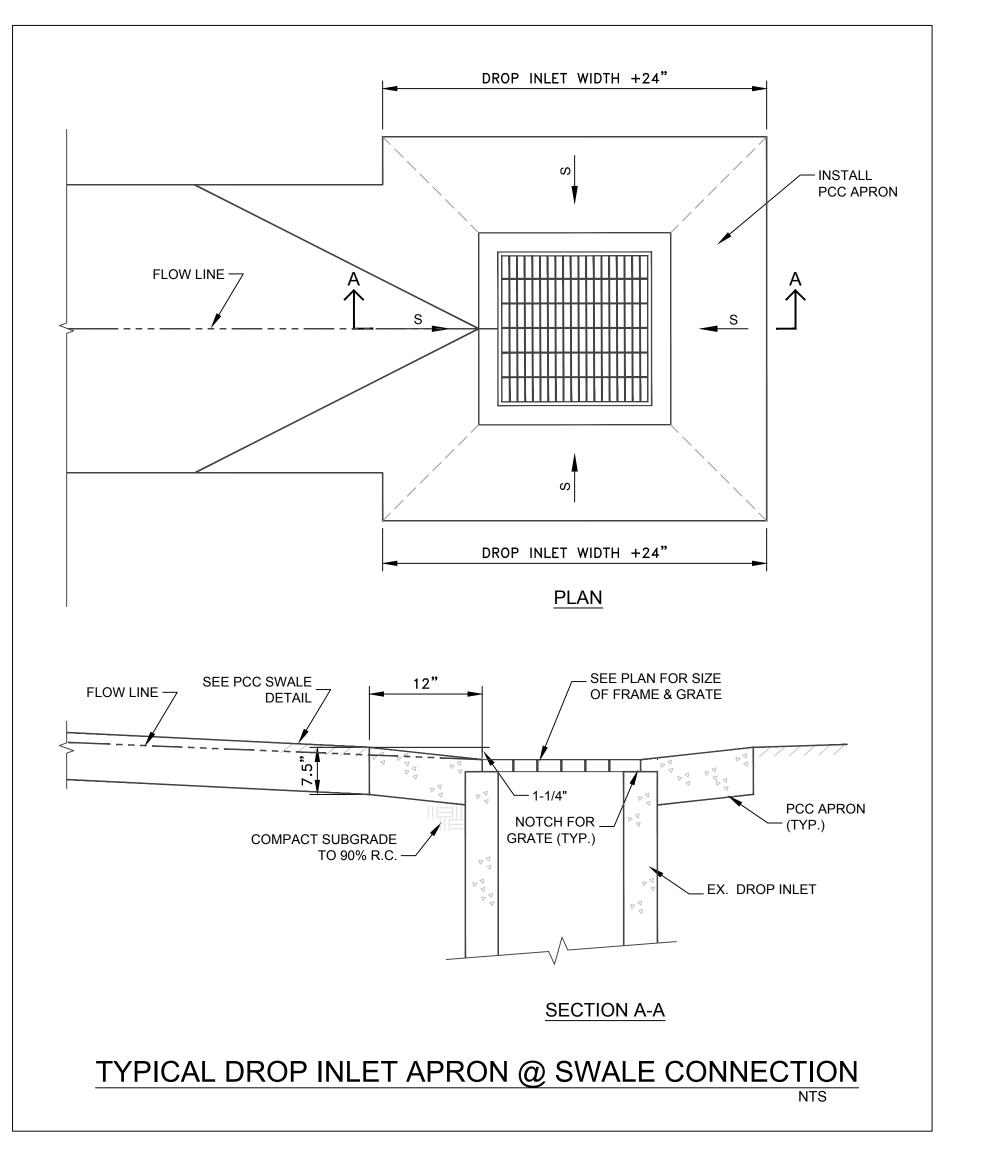


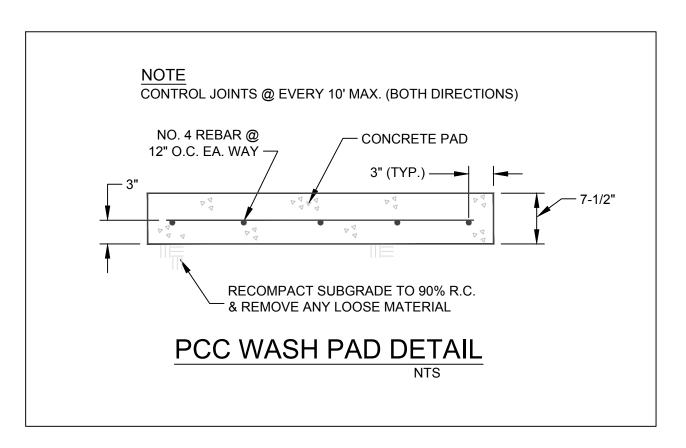

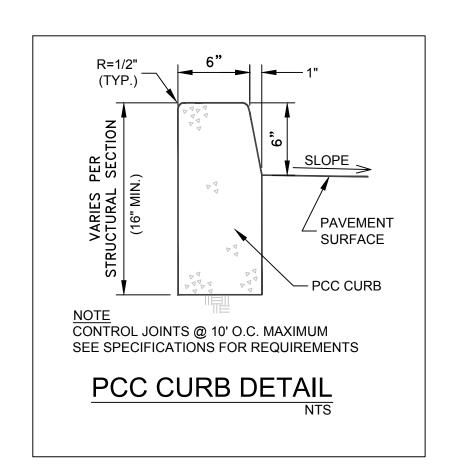


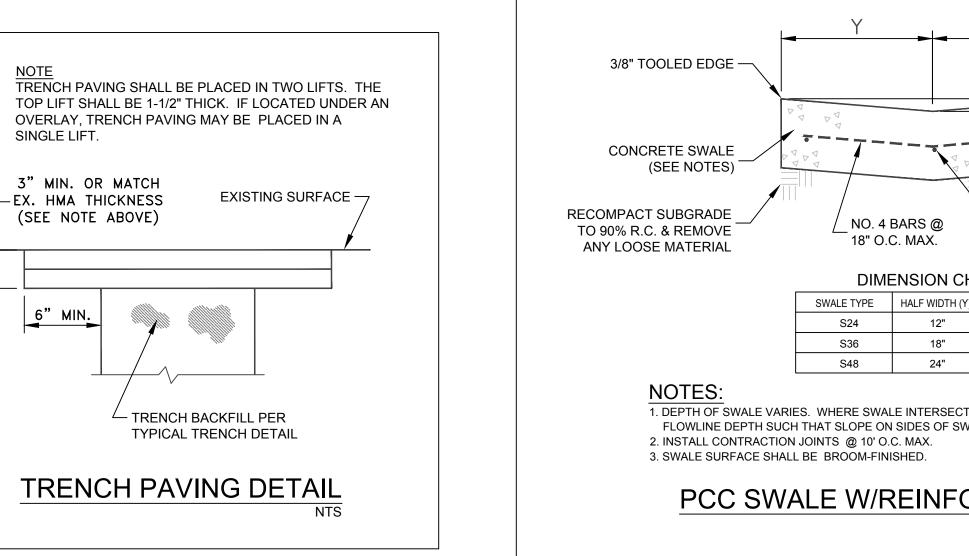


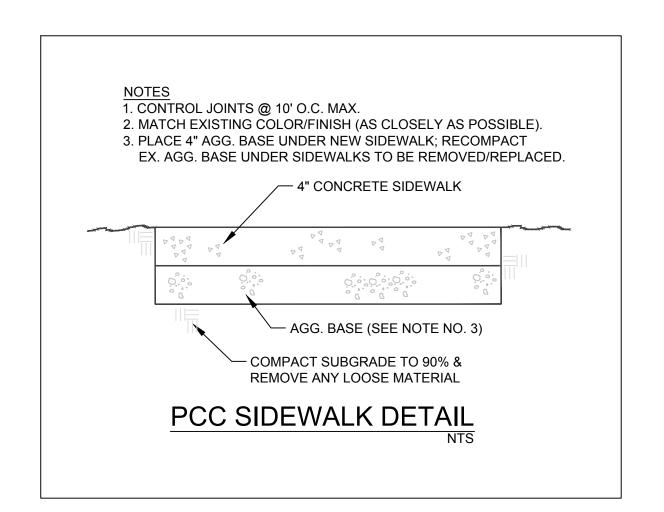

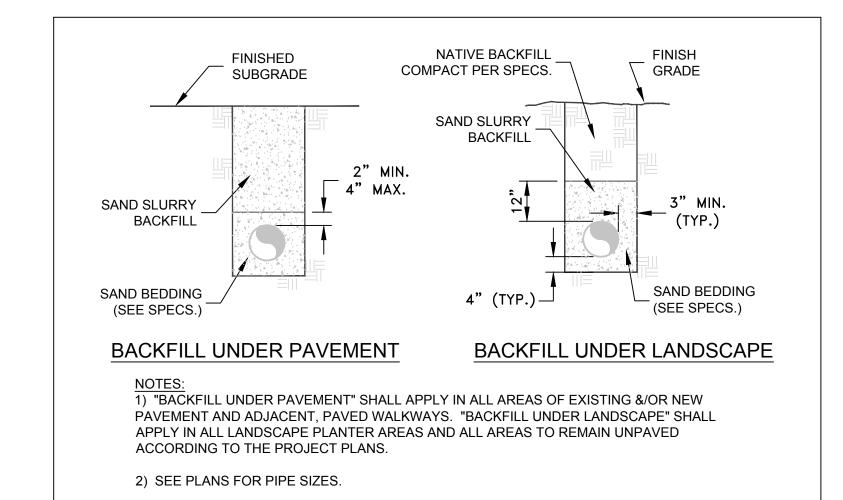

TYPICAL TRENCH BACKFILL DETAIL

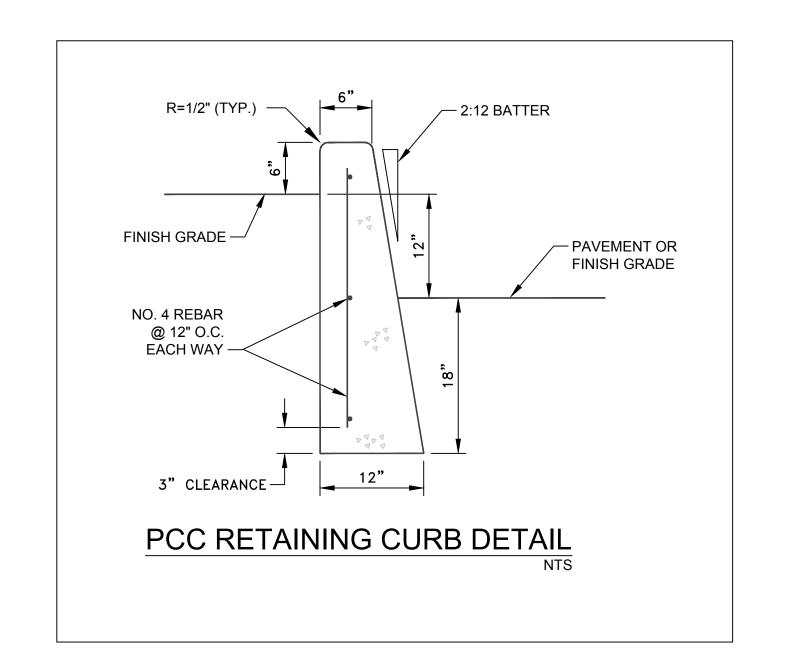

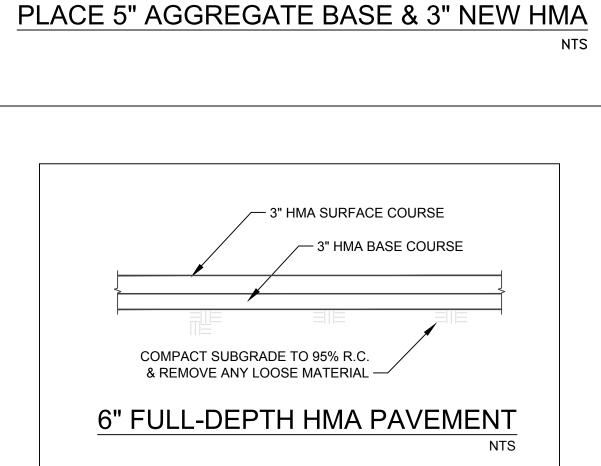

TREAT SOIL TO A DEPTH OF 15" WITH LIME/CEMENT;

- PLACE 6-3/4" NEW HMA

- 5" CLASS II AGGREGATE


BASE; COMPACT TO 95%


**EXISTING OR NEW** 


PCC FACILITIES -

TREAT SOIL TO A DEPTH

OF 15" WITH LIME/CEMENT, REGRADE & COMPACT TO 95% R.C. —

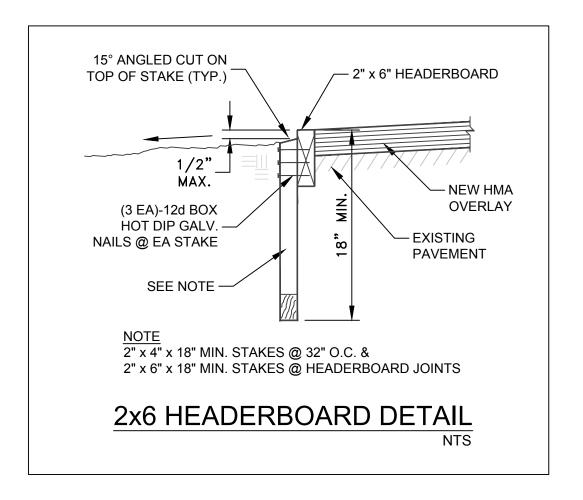

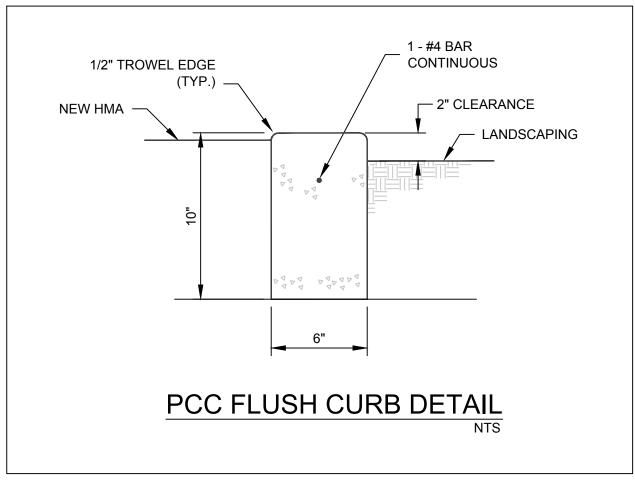

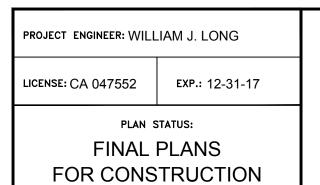



Redding Office

San Luis Obispo Office

(530) 224-4535

EAST SIDE UNION HIGH SCHOOL DISTRICT 830 NORTH CAPITOL AVENUE SAN JOSE, CA NTS APPROVED BY: DATE: JAN. 2017 REVISED: 2017 TRANSPORTATION YARD RELOCATION PROJECT **DETAIL PLAN** EAST SIDE UNION HIGH SCHOOL DISTRICT DRAWING NUMBER 150227-01

	FIXTURE SCHEDULE								
TYPE	DESCRIPTION & MANUFACTURER	LAMPS	INPUT WATTS	MOUNTING	REMARKS				
	NEW LED FIXTURE AND POLE, BRONZE, SINGLE HEAD, DOUBLE MODULE 240VOLT MOTION SENSOR, 50%-100% DIMMING CONTROL	8200 LMS 4000K	101	15'-0" POLE	17'-0" MTG. HEIGHT TYPE 3 GENERAL NOTE #21,22				
	CREE: #BXSP-HT-3ME-B-40K-UL-BZ-ML								
$\langle A2 \rangle$	NEW LED FIXTURE AND POLE, BRONZE DOUBLE HEAD, 240VOLT MOTION SENSOR, 50%— 100% DIMMING CONTROL CREE: #(2)BXSP-HT-4ME-B-40K-UL-BZ-ML	(2) 8200 LMS 4000K	202	15'-0" POLE 2	17'-0" MTG. HEIGHT TYPE 4 GENERAL NOTE #21,22				

### GENERAL NOTES

- 1. ALL WORK SHALL CONFORM TO THE 2013 CALIFORNIA ELECTRICAL CODE, 2013 NON RESIDENTIAL COMPLIANCE MANUAL AND ALL STATE AND MUNICIPAL CODES AND ORDINANCES. FEEDER CIRCUITS MINIMUM 2% VOLTAGE DROP. BRANCH CIRCUITS MINIMUM 3% VOLTAGE DROP.
- 2. CIRCUITRY AND CONDUIT ROUTING SHOWN ON THE PLANS IS DIAGRAMMATIC ONLY. THE CONTRACTOR IS RESPONSIBLE FOR BECOMING COMPLETELY FAMILIAR WITH THE SITE AND STRUCTURAL CONDITIONS AND LIMITATIONS WHICH WILL EXIST AND TO PROVIDE ALL LABOR, TOOLS AND MATERIALS REQUIRED TO PRODUCE A COMPLETELY CONCEALED INSTALLATION WHEREVER INDICATED ON THE PLANS.
- 3. COORDINATE ALL ELECTRICAL WORK WITH THE OTHER TRADES.
- 4. THE ELECTRICAL CONTRACTOR SHALL COORDINATE ALL WORK WITH THE EXTERIOR LANDSCAPE PLANS. THE REQUIREMENTS OF ALL EQUIPMENT SHALL BE VERIFIED PRIOR TO THE INSTALLATION OF THE ELECTRICAL WORK.
- 5. ALL ELECTRICAL EQUIPMENT USED EXPOSED AND/OR SURFACE MOUNTED SHALL BE WEATHERPROOF.
- 6. WHERE MATERIALS, EQUIPMENT, APPARATUS, OR OTHER PRODUCTS ARE SPECIFIED BY MANUFACTURER, BRAND NAME, TYPE, OR CATALOG NUMBER SUCH DESIGNATION IS TO ESTABLISH STANDARDS OF DESIRED QUALITY AND STYLE AND SHALL BE THE BASIS OF THE BID. MATERIAL SO SPECIFIED SHALL BE FURNISHED UNDER THE CONTRACT UNLESS A CHANGE IS AUTHORIZED IN WRITING. ACCEPTANCE OR REJECTION OF THE PROPOSED SUBSTITUTIONS SHALL BE SUBJECT TO APPROVAL OF THE ENGINEER. IF REQUESTED BY THE OWNER, THE CONTRACTOR SHALL SUBMIT FOR INSPECTION SAMPLES OF BOTH THE SPECIFIED AND PROPOSED SUBSTITUTE TERMS.
- 7. INSPECT AND MAKE NECESSARY TEST WHICH THE OWNER MAY REQUEST TO INSURE THAT THE ELECTRICAL EQUIPMENT IS INSTALLED CORRECTLY AND THAT THE WIRING SYSTEMS ARE FREE OF ALL SHORTS, GROUNDS, AND FAULTY CONNECTIONS AND HAVE INSULATION RESISTANCE BETWEEN CONDUCTORS AND GROUNDS OF NOT LESS THAN THE REQUIREMENTS OF THE NATIONAL ELECTRIC CODE.
- 8. ALL CONDUCTORS SHALL BE COPPER, INSTALLED IN CONDUIT.
- 9. ALL ELECTRICAL EQUIPMENT SHALL BE GROUNDED AND BONDED IN ACCORDANCE WITH THE NATIONAL ELECTRICAL CODE AND ALL LOCAL CODES AND REQUIREMENTS.
- 10. INCLUDE GREEN COPPER GROUND WIRE IN ALL CONDUITS FROM THE PANELBOARD GROUND BAR TO RECEPTACLE AND EQUIPMENT GROUND LUGS. SIZES PER CODE.
- 11. ALL MATERIALS SHALL BE NEW, OF THE BEST QUALITY, AND SHALL BE APPROVED BY THE UNDERWRITERS' LABORATORIES AND EACH LENGTH OF CONDUIT SHALL BEAR THE U.L. LABEL.
- 12. NON-METALLIC CONDUIT: PVC HIGH IMPACT 90°C POLYVINYL CHLORIDE, SCHEDULE 40 WITH FACTORY SPACERS, COUPLINGS, BENDS AND OFFSETS. PLASTIC CONNECTIONS TIGHTLY FITTED AND BUTTED, CEMENT WELDED UTILIZING TINTED PRIMER PER ASTMF656 AND HEAVY BODY, MEDIUM SET CEMENT PER ASTMD2564, IN ACCORDANCE WITH MANUFACTURER'S DIRECTIONS. PLASTIC TO METAL CONNECTION WITH UL LISTED ADAPTERS.
- 13. FITTINGS: PROVIDE FITTING AND ACCESSORIES APPROVED FOR THE PURPOSE AND EQUAL IN ALL RESPECTS TO THE CONDUIT OR RACEWAY.
- 14. RECEPTACLES SHALL BE RATED 125 VOLTS COMMERCIAL SPECIFICATION GRADE, HUBBELL, ARROW—HART, LEVITRON OR EQUAL.
- 15. WEATHERPROOF DEVICE PLATES SHALL BE LIFT-LID POLYCARBONATE HINGED COVER AND LOCKABLE.
- 16. INSTALL PULLROPE IN ALL EMPTY CONDUITS (C.O.) TAG EACH END.
- 17. CONDUIT SYSTEM SHALL BE ELECTRICALLY CONTINUOUS WITH ALL BOXES AND CONDULETS READILY ACCESSIBLE.
- 18. FIXTURE LOCATION: ALL LIGHT FIXTURE LOCATIONS TO BE VERIFIED BY SCHOOL DISTRICT AND ENGINEER BEFORE COMMENCING INSTALLATION. ALL FIXTURES SHALL BE IN A NEW, UNUSED CONDITION.
- 19. EQUIPMENT SHALL BE THE TYPE SPECIFIED. THERE WILL BE NO SUBSTITUTIONS WITHOUT PRIOR APPROVAL FROM THE ENGINEER. ELECTRICAL CONTRACTOR TO FURNISH NEW PHOTOMETRIC LAYOUTS FOR ALTERNATE FIXTURES. ELECTRICAL CONTRACTOR TO INSTALL ALL EQUIPMENT AS PER MANUFACTURER'S SPECIFICATIONS AND DETAILS.
- 20. ELECTRICAL CONTRACTOR TO INCLUDE FULL DOCUMENTATION OF COMMISSIONING COMPLIANCE FORMS AND CERTIFICATE REQUIREMENTS PER 2013 BUILDING EFFICIENCY STANDARDS 130.4 IN BASE BID.
- 21. PARKING LOT LIGHTING: TIMECLOCK OFF-ON. MOTION SENSOR CONTROL 50%-NO MOTION AND 100%-ACTIVE MOTION. REFER TO CREE LED MUTLTI-LEVEL OPTIONS.
- 22. <u>CREE</u>: #PS4S15C, 15'-0" NON-TRAPED SQUARE STEEL POLE WITH COVER PLATE, BRONZE FINISH, TYPE A-SINGLE HEAD, TYPE A2-TWIN HEAD (108°) WITH OPTION 20AMP, 120VOLT GFI RECEPTACLE WITH LOCKABLE COVER.
- 23. ALL NEW CIRCUIT BREAKERS SHALL MATCH EXISTING AIC AT EXISTING PANEL FP.
- 24. NOTHING IN THESE PLANS ARE TO BE CONSTRUED TO PERMIT WORK NOT CONFORMING TO LOCAL CODES. HOWEVER, WHEN THESE SPECIFICATIONS CALL FOR OR DESCRIBE MATERIALS OR CONSTRUCTION OF A BETTER QUALITY, OR LARGER SIZE THAN REQUIRED BY THE ABOVE MENTIONED RULES AND REGULATIONS, THE PROVISIONS OF THESE SPECIFICATIONS SHALL TAKE PRECEDENCE OVER REQUIREMENTS OF THE SAID RULES AND REGULATIONS.
- 25. FURNISH, WITHOUT EXTRA CHARGE TO OWNER, ALL ADDITIONAL MATERIAL AND LABOR WHEN AND WHERE REQUIRED TO COMPLY WITH THESE RULES AND REGULATIONS, THOUGH THE WORK MAY BE NOT MENTIONED IN THESE SPECIFICATIONS OR SHOWN ON THE PLANS.
- 26. THE WORK UNDER THIS SECTION SHALL INCLUDE COMPETENT DIRECTION AND FIRST-CLASS MECHANICS TO MAKE THE INSTALLATION AND COMPLETE THE WORK IN CONFORMITY WITH THE INTENT OF THE PLANS AND SPECIFICATIONS.
- 27. EACH SUBMITTAL SHALL BE ACCOMPANIED BY A COVER LETTER OR SHALL BEAR A STAMP STATING THAT THE SUBMITTAL HAS BEEN REVIEWED BY THE CONTRACTOR AND IS IN COMPLIANCE WITH THE REQUIREMENTS OF THE CONTRACT DOCUMENTS. COVER LETTERS SHALL LIST IN FULL THE ITEMS AND DATA SUBMITTED.
- 28. INSPECT AND MAKE NECESSARY TEST WHICH THE OWNER MAY REQUEST TO INSURE THAT THE ELECTRICAL EQUIPMENT IS INSTALLED CORRECTLY AND THAT THE WIRING SYSTEMS ARE FREE OF ALL SHORT, GROUNDS AND FAULTY CONNECTIONS AND HAVE INSULATION RESISTANCE BETWEEN CONDUCTORS AND GROUNDS OF NOT LESS THAN THE REQUIREMENT OF THE NATIONAL ELECTRIC CODE.

PROFESSIONAL SLAUGINESS EN 6-30-17

REVISIONS

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Electrical Consulting Engineer
3820 Cypress Drive, Suite 1
Petaluma, Ca. 94954
(707)762-3310
EAX (707)762-3610

ast Side Union High School District District Transportation Yard 830 North Capitol Avenue San Jose, California

GENERAL NOTES, FIXTURE SCHEDULE AND SHEET INDEX

Date: 02-23-2017

Drawn: RESA

Job: 1704

300.

E0.1

SHEET INDEX

GENERAL NOTES, FIXTURE SCHEDULE AND SHEET INDEX EXTERIOR TITLE 24

E1.1 SITE PLAN

SITE PLAN


	OF CALIFORNIA	
	TDOOR LIGHTING CONTROLS  (CC-LT0-02-E (Revised 06/14)	CALIFORNIA ENERGY COMMISSION
CER	TIFICATE OF COMPLIANCE	NRCC-LT0-0
Outo	oor Lighting Controls	(Page 1 c
Project	EAST SIDE UNION HIGH SCHOOL DISTRICT	Date Prepared: 02-21-2017
The	NRCC-LTO-020-E shall be used to document all mandatory outdoor lighting controls that are applicable to the project.	
	datory Outdoor Lighting Control Declaration Statements ck all that apply:	
	Lighting shall be controlled by self-contained lighting control devices which are certified the Energy Commission according to the T Efficiency Regulations in accordance with 110.9.	itle 20 Appliance
×	Lighting shall be controlled by a lighting control system or energy management control system in accordance with 110.9. An Install shall be submitted in accordance with 130.4(b).	ation Certificate
×	All lighting controls and equipment shall comply with the applicable requirements in 110.9 and shall be installed in accordance with Instructions in accordance with 130.1	the manufacturer's
	Part-Night Outdoor Lighting Controls, as defined in section 100.1, shall meet the requirements in section 110.9 (b)5	
	All outdoor incandescent luminaires rated over 100 watts, determined in accordance with Section 130.0(c), shall be controlled by a	motion sensor,
	All outdoor luminaires rated for use with lamps greater than 150 lamp watts, determined in accordance with Section 130.0(c) shall Backlight, Uplight, and Glare (collectively referred to as "BUG") in accordance with Section 130.2(b)	comply with
	All installed outdoor lighting shall be controlled by a photocontrol or outdoor astronomical time-switch control in accordance With S	ection 130.2(c)1
×	All installed outdoor lighting shall be circuited and Independently controlled from other electrical loads by an automatic scheduling accordance with Section 130.2(c)2	control in
	All installed outdoor lighting, where the bottom of the luminairs is mounted 24 feet or less above the ground, shall be controlled wit lighting controls in accordance with Section 130.2(c)3	h automatic
	For Outdoor Sales Frontage, Outdoor Sales Lots, and Outdoor Sales Canopies lighting, and automatic lighting control in accordan 130.2(c)4	ce with Section
	For Building Facade, Ornamental Hardscape and Outdoor Dining lighting, an automatic lighting control in accordance with Section	130.2(c)5
×	Before an occupancy permit is granted for a newly constructed building or area, or a new lighting system serving building area, or sinormal use, indoor lighting controls serving the building, area, or site shall be certified as meeting the Acceptance Requirements for accordance with 130 (a). Outdoor lighting controls shall comply with the applicable requirements of Section 130.2(c) and Reference Appendix NA7,8	Code Compliance in

CA Building Energy Efficiency Standards - 2013 Nonresidential Compliance

OUTDOOR LIGHTING CONTROLS CERTIFICATE OF COMPLIANCE Outdoor Lighting Controls Project Name EAST SIDE UNION HIGH SCHOOL DISTRIC MANDATORY OUTDOOR LIGHTING CONTROL SCHEDULE and FIELD INSPECTION CHECKLIST Standards Complying With 1 ( all that apply, or other 'E' If Exempted) Outdoor Lighting Control Schedule Type/Description of Lighting Control (Le. motion sensor, photocontrol, outdoor astronomical time-switch control, Location and Application of Luminaires being controlled centralized time-based zone lighting control) **OUTDOOR LIGHTING CONTROLS** CERTIFICATE OF COMPLIANCE NRCC-LT0-02-E Project Name EAST SIDE UNION HIGH SCHOOL DISTRICT DOCUMENTATION AUTHOR'S DECLARATION STATEMENT

1.1 Certify that this certificate of Compliance documentation is accurate and complete

PAY SLAUGHTER RAY E. SLAUGHTER & ASSOCIATES 3820 CYPRESS DRIVE, SUITE 1 y/State/Zip: PETALUMA, CALIFORNIA 94954 <sup>se:</sup> (707)762-3310 RESPONSIBLE PERSON'S DECLARATION STATEMENT I certify the following under penalty of of perjury, under the laws of the state of California: The Information provided on this Certificate of Compliance is true and correct. I am eligible under Division 3 of the Business and Professions Code to accept responsibility for the building design or system design identified o this Certificate of compliance (responsible designer). The energy features and performance specifications, materials, components, and manufactured devices for the building design system design identified on this Certificate of Compliance conform to the requirements of Title 24, Part 1 and Part 6 of the California Code of Regulations, The building design features pr system design features identified on this Certificate of Compilance are consistent with the information provide on other applicable compilance documents, worksheets, calculations, plans and specifications submitted to the enforcement agency for approval with this building permit application. I Will ensure that a completed signed copy of this Certificate of Compilance shall be made available with the building permit(s) issued for the building, and made available to the enforcement agency for all applicable inspections. I understand that a completed signed copy of this Certificate of Compilance is required to be included with the documentation t builder provides to the building owner at occupancy. esponsible Designer Name: RAY SLAUGHTER RAY E. SLAUGHTER & ASSOCIATES 3820 CYPRESS DRIVE, SUITE 1 nse: E10745 Phase: (707)762-3310 PETALUMA, CALIFORNIA 94954

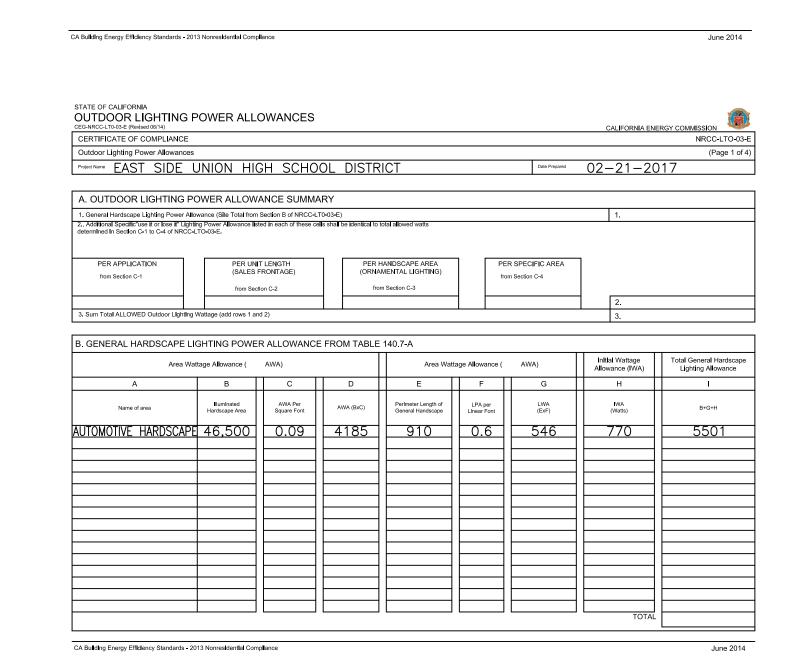

Project Name EAST SIDE UNION HIGH SCHOOL DISTRICT Date Prepared: 02-21-2017 A. OUTDOOR LIGHTING SCHEDULE and FIELD INSPECTION ENERGY CHECKLIST Cutoff Luminaire Schedule Installed Watts Location How wattage was determined Complete Luminaire Description 101 □ 🛛 4 404 PARKING A PARKING AREA LED INSTALLED WATTS PAGE TOTAL: Enter sum total of all pages (Sum Total 1212 1212 INSTALLED Outdoor lighting wattage) into NRCC-LTO-01-E: Page 2 CA Building Energy Efficiency Standards - 2013 Nonresidential Compliance

CALIFORNIA ENERGY COMMISSION

OUTDOOR LIGHTING

CERTIFICATE OF COMPLIANCE

CA Building Energy Efficiency Standards - 2013 Nonresidential Compliance

CA Building Energy Efficiency Standards - 2013 Nonresidential Compliance

(Page 2 of 3)

OUTDOOR LIGHTING CALIFORNIA ENERGY COMMISSION ERTIFICATE OF COMPLIANCE Project Name EAST SIDE UNION HIGH SCHOOL DISTRICT Date Prepared 02-21-2017 DOCUMENTATION AUTHOR'S DECLARATION STATEMENT 1. I certify that this certificate of Compliance documentation is accurate and comple RAY SLAUGHTER RAY E. SLAUGHTER AND ASSOCIATES 3820 CYPRESS DRIVE, SUITE 1 nase: (707)762-3310 PETALUMA, CALIFORNIA 94954 RESPONSIBLE PERSON'S DECLARATION STATEMENT I certify the following under penalty of of perjury, under the laws of the state of California: The Information provided on this Certificate of Compliance is true and correct. I am eligible under Division 3 of the Business and Professions Code to accept responsibility for the building design or system design identified o this Certificate of compliance (responsible designer). The energy features and performance specifications, materials, components, and manufactured devices for the building design system design identified on this Certificate of Compliance conform to the requirements of Title 24, Part 1 and Part 6 of the California Code of Regulations, The building design features pr system design features identified on this Certificate of Compliance are consistent with the information provide on other applicable compliance documents, worksheets, calculations, plans and specifications submitted to the enforcement agency for approval with this building permit application. I Will ensure that a completed signed copy of this Certificate of Compliance shall be made available with the building permit(s) issued for the building, and made available to the enforcement agency for all applicable inspections. I understand that a completed signed copy of this Certificate of Compliance is required to be included with the documentation the builder provides to the building owner at occupancy. umentation Author Name: RAY SLAUGHTER RAY E. SLAUGHTER AND ASSOCIATES 3820 CYPRESS DRIVE, SUITE 1 E10745 PETALUMA, CALIFORNIA 94954 se: (707)762-3310

STATE OF CALIFORNIA OUTDOOR LIGHTING POWER ALLOWANCES CEG-NRCC-LT0-03-E (Revised 06/14)	CALIFORNIA ENERGY COMMISSION
CERTIFICATE OF COMPLIANCE	NRCC-LTO-
Outdoor Lighting Power Allowances	(Page 4
Project Name EAST SIDE UNION HIGH SCHOOL DISTRIC	T Date Prepared: 02-21-2017
DOCUMENTATION AUTHOR'S DECLARATION STATEMENT	
1. I certify that this certificate of Compliance documentation is accurate and complete.  Documentation Author Name:  DANCOLABORATE DE	Documentation Author Name:
RAY SLAUGHTER	Documentation Author Name.
Company: RAY E. SLAUGHTER & ASSOCIATES	Signature Date:
Address: 3820 CYPRESS DRIVE, SUITE 1	CEA/HEPS Certification Identification (if applicable)
City/State/Zip: PETALUMA, CALIFORNIA 94954	Phase: (707)762-3310
RESPONSIBLE PERSON'S DECLARATION STATEMENT	
I certify the following under penalty of of perjury, under the laws of the state of California:	
The information provided on this Certificate of Compliance is true and correct.	
<ol> <li>I am eligible under Division 3 of the Business and Professions Code to accept responsibility for the building design (responsible designer).</li> </ol>	or system design identified o this Certificate of compliance
<ol> <li>The energy features and performance specifications, materials, components, and manufactured devices for the bu Compilance conform to the requirements of Title 24, Part 1 and Part 6 of the California Code of Regulations,</li> </ol>	lding design system design Identified on this Certificate of
<ol> <li>The building design features pr system design features identified on this Certificate of Compilance are consistent v documents, worksheets, calculations, plans and specifications submitted to the enforcement agency for approval v</li> </ol>	ith the Information provide on other applicable compilance Ith this building permit application.
<ol> <li>I Will ensure that a completed signed copy of this Certificate of Compliance shall be made available with the building enforcement agency for all applicable inspections. I understand that a completed signed copy of this Certificate of builder provides to the building owner at occupancy.</li> </ol>	
Responsible Designer Name: RAY SLAUGHTER	Responsible Designer Name:
RAY E. SLAUGHTER & ASSOCIATES	Date Signature:
3820 CYPRESS DRIVE, SUITE 1	License: E10745

STATE OF CALIFORNIA
OUTDOOR LIGHTING CALIFORNIA ENERGY COMMISSION (Page 1 of 4) Outdoor Lighting Project Name EAST SIDE UNION HIGH SCHOOL DISTRICT Date Prepared: 02-21-2017 Project Address: 830 NORTH CAPITOL AVENUE Total Illuminated Hardscape Area SAM JOSE, CALIFORNIA OLZ-1 Outdoor Lighting Zone (OLZ) I have confirmed with the AHJ which OLZ applies to this site. For default lighting zone designations, see Title 24 Part 6, 10-114 LIGHTING COMPLIANCE DOCUMENTS (check box for each document included) For detailed instructions on the use of the and all Energy Efficiency Standards compliance documents, refer to the Nonresidential Manua published by the California Energy Commission.

NRCC-LTO-01-E

NRCC-LTO-02-E NRCC-LTO-03-E Certificate Lighting Power Allowance Certificate of Compliance Summery of Allowed Outdoor Lighting Power

= 5501 Sum Total ALLOWED Outdoor Lighting Wattage from NRCC-LTO-03-E, PAGE 1 Complies ONLY if Installed & Allowed Sum Total INSTALLED Outdoor Lighting Wattage from NRCC-LTO-01-E, PAGE 3 1212

Declaration of Required Installation Certificates-Declare by checking all Installation Certificates that will be submitted. (Retain copies and verify forms are completed and signed.) NRCI-LTO-01-E Must be submitted for buildings Field Inspector ■ NRCI-LTO-02-E Must be submitted for a lighting control system, or for an Field Inspector Energy Management control system (EMCS), be recognized for compliance. Declaration of Required Certificates of Acceptance-Declare by checking all of the Certificates of Acceptance that will be submitted. (Retain copies and verify forms are completed and signed.) NRCA-LTO-02-A-Must be submitted for outdoor lighting controls. Fleid Inspector

CA Building Energy Efficiency Standards - 2013 Nonresidential Compliance


STATE OF CALIFORNIA
OUTDOOR LIGHTING ALIFORNIA ENERGY COMMISSION CERTIFICATE OF COMPLIANCE Outdoor Lighting Project Name EAST SIDE UNION HIGH SCHOOL DISTRICT Date Propurate: 02-21-2017 Field Inspector ☐ NRCI-LTO-01-E-Must be submitted for all buildings Field Inspector ☐ NRCI-LTO-02-E-Must be submitted for a lighting control system, or for an Energy Management Control System (EMCS), to be recognized for compliance. Declaration of Required Certificates of Acceptance-Declare by checking all of the Certificates of Acceptance that will be submitted. (Retain copies and verify forms are completed and signed.) Field Inspector ☐ NRCA-LTO-02-A-Must be submitted for outdoor lighting controls.

Schedule of luminaires	John January Mariana M
Name or Symbol	Description of exempt luminaire in accordance with the exemptions
Schedule of luminaires	s exempt from the cutoff requirements in 130.2(b)
Schedule of luminaires	s exempt from the cutoff requirements in 130.2(b)  Description of exempt luminaire in accordance with the exemptions

Schedule of luminaires	s exempt from the outdoor lighting power requirements in 130.2(c)				
Name or Symbol Description of exempt luminaire in accordance with the exemptions					

CA Building Energy Efficiency Standards - 2013 Nonresidential Compliance

**REVISIONS** 

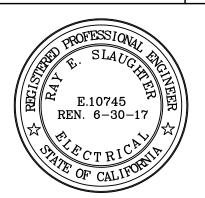


District 0 Ŏ ch Side


**EXTERIOR** TITLE 24


Date: 02-23-2017

Drawn: RESA Job: 1704

E0.2

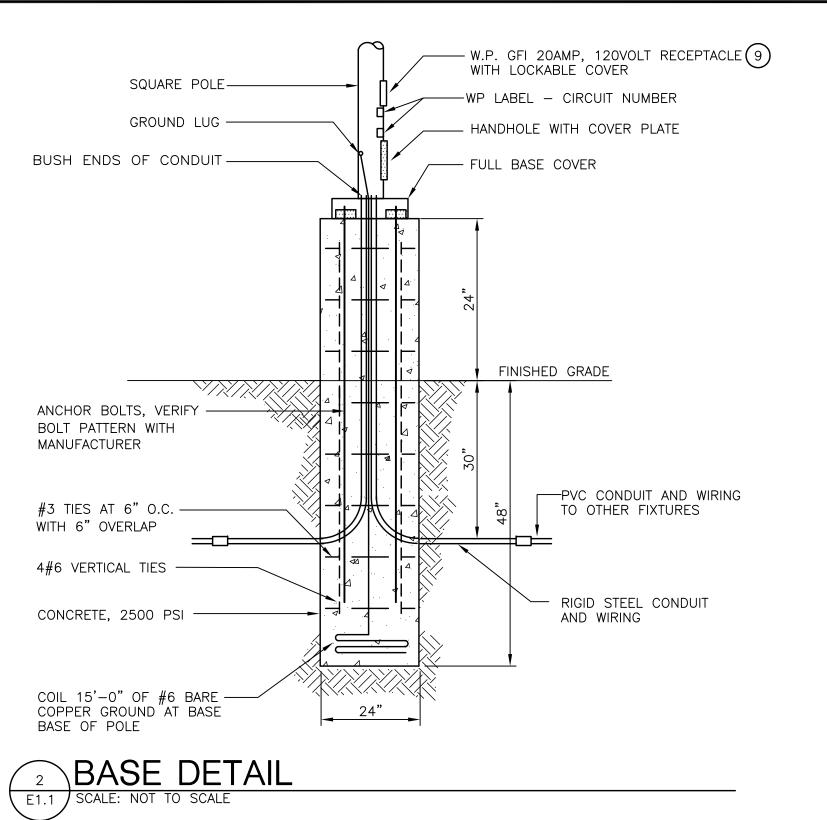

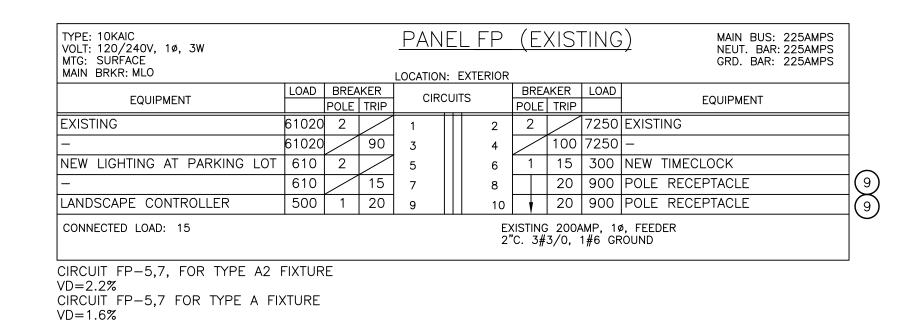

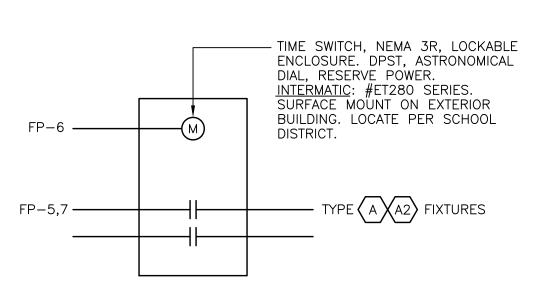

# 3 EXTERIOR LIGHTING CONTROLS E1.1 SCALE: NOT TO SCALE

SHEET NOTES

1) INSTALL NEW BREAKERS IN EXISTING PANEL FOR LIGHTING, TIMECLOCK AND RECEPTACLE. MATCH EXISTING ATC RATING.

2 NEW NEMA 3R INTERMATIC TIMECLOCK, 120VOLT ASTRONOMICAL DIAL. LOCKABLE COVER.

3 CHRISTY N9 PULLBOX. FLUSH WITH GRADE. FIELD VERIFY LOCATION.

4 BRANCH CIRCUIT CONDUITS ALONG SIDE OF BUILDING. COORDINATE ROUTE WITH DISTRICT. EMT CONDUIT WITH COMPRESSION FITTINGS AND COPPER CONDUCTORS. 3/4"C. 4#10, 2#10 GROUND FOR POLE LIGHTING/RECEPTACLE, 3/4"C. 2#10, 1#12 GROUND FOR LANDSCAPE CONTROLLER.

(5) DOWN SIDE OF BUILDING. FIELD VERIFY.


6 3/4"C. 2#10, 1#10 GROUND LIGHTING CIRCUIT AND 2#10, 1#10 GROUND RECEPTACLE CIRCUIT. MINIMUM 24" BELOW GRADE OR DEPTH PER SCHOOL DISTRICT.

WALL MOUNTED LANDSCAPE CONTROLLER, 120VOLT, HARD WIRED CONNECTION. FIELD VERIFY LOCATION PRIOR TO ROUGH—IN ON WALL OR ON PEDESTAL. SEE LANDSCAPE

8 REFER TO MANUFACTURE SUBMITTAL SHEETS FOR SINGLE HEAD AND DUAL HEAD MOUNTING REQUIREMENTS.

9 POLE RECEPTACLE NOT ON TIME SWITCH CONTROL.

**REVISIONS** 

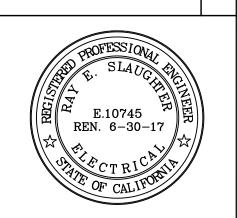

Hay E. Sigu inter & Associate
Electrical Consulting Engineer
3820 Cypress Drive, Suite 1
Petaluma, Ca. 94954
(707)762-3310
FAX (707)762-3610

East Side Union High School District
District Transportation Yard
830 North Capitol Avenue
San Jose, California

PARKING LOT LIGHTING SITE PLAN


ŀ	Date:	02-23-2017
	Scale:	1"=20'-0"


Drawn: RESA

Job: 1704

Job:

E1.1

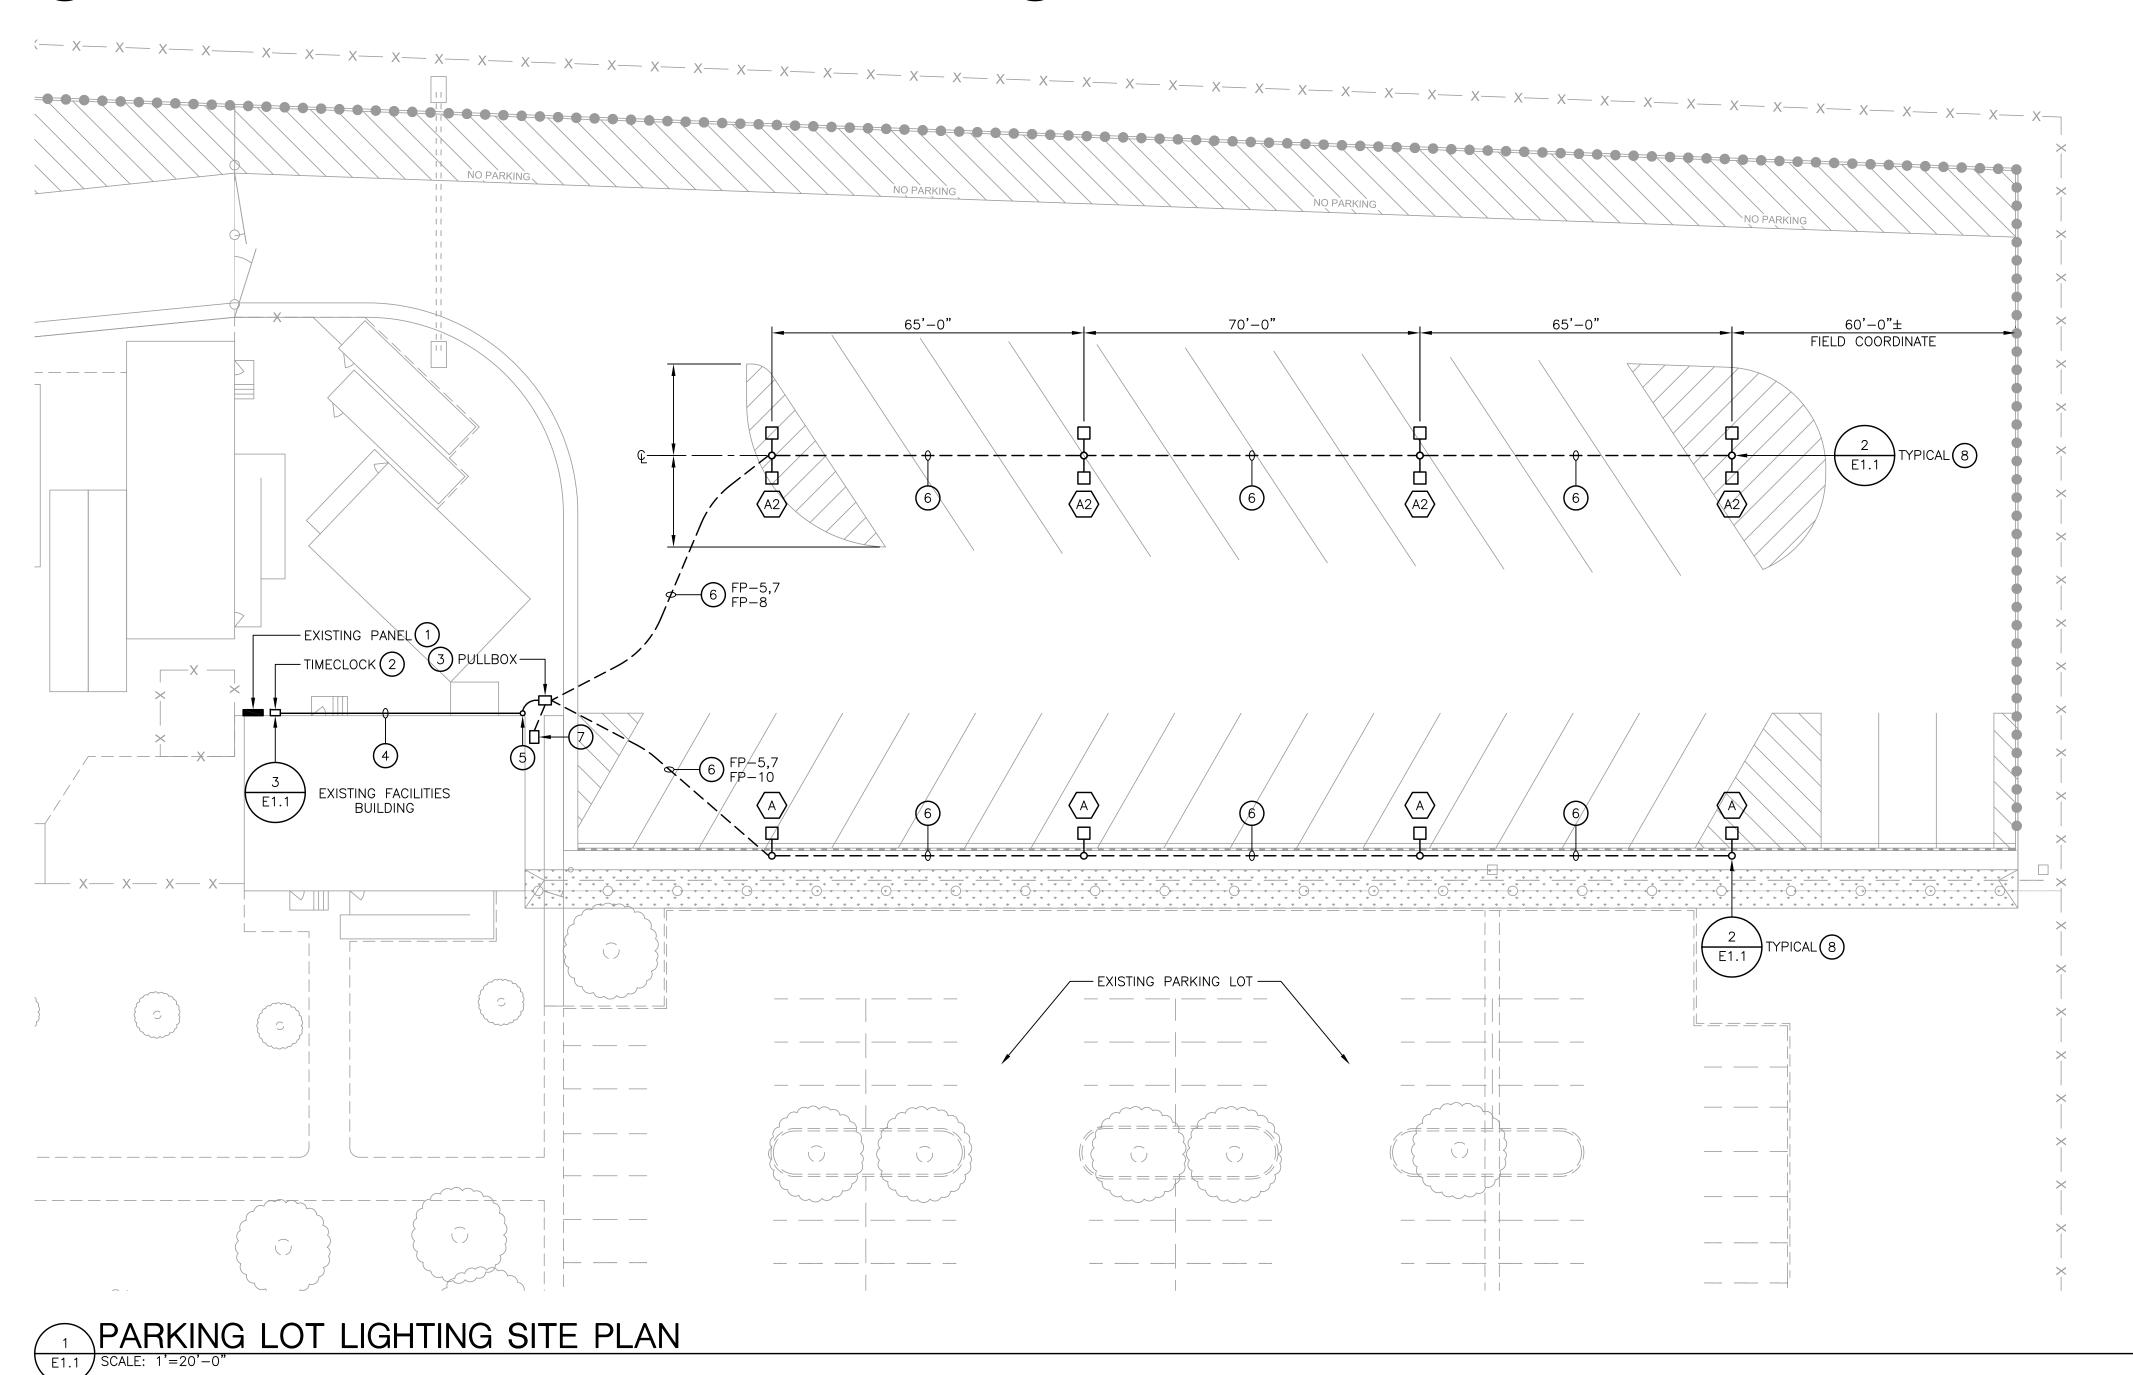

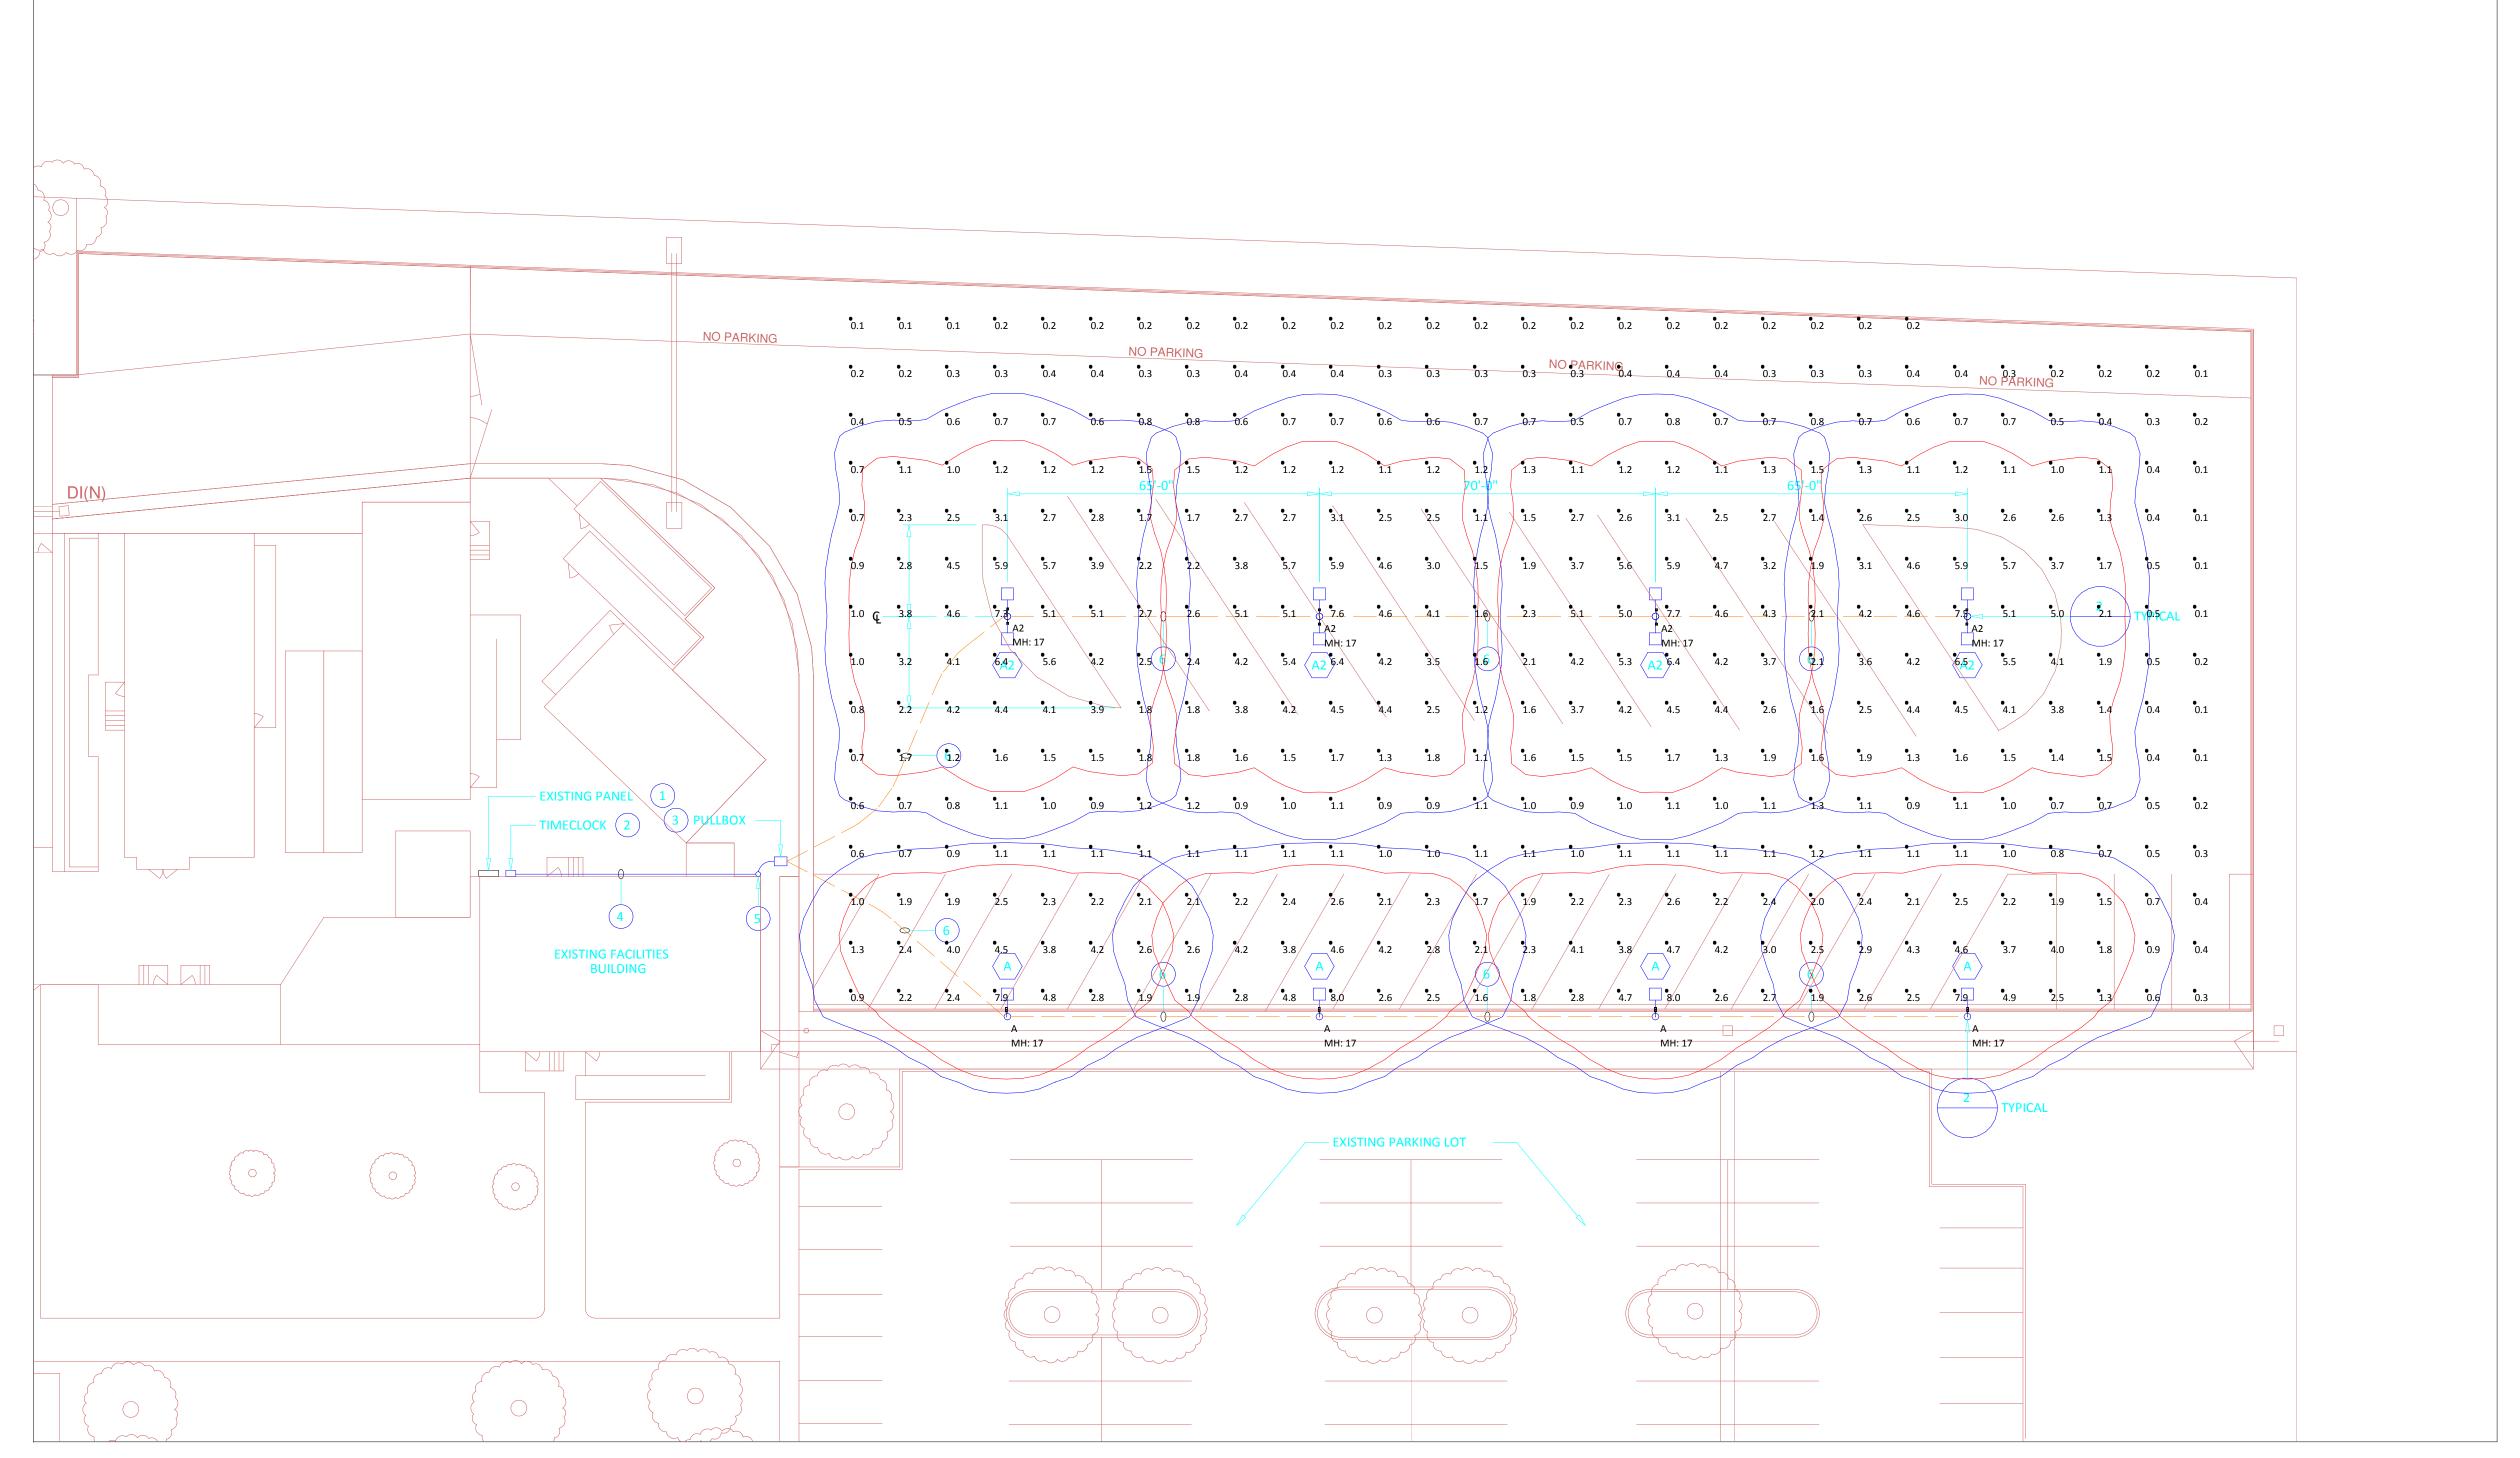

Plan View Scale: 1 inch= 20 Ft.

 Luminaire Schedule

 Symbol
 Qty
 Label
 Description
 LLF
 Lum. Lumens
 Lum. Watts

 □□ 4
 A
 Cree BXSP-B-HT-3ME-B-40K-UL-BZ-ML
 0.846
 10260
 99.07

 □□ □ 4
 A2
 Cree BXSP-B-HT-4ME-B-40K-UL-BZ-ML (2@180)
 0.846
 9758
 101

Calculation Summary							
Label	CalcType	Units	Avg	Max	Min	Avg/Min	Max/Min
Parking	Illuminance	Fc	2.08	8.0	0.1	20.80	80.00

LIGHTING SYSTEMS

www.ltgsys.com

510-982-3900 2322 6th Street Berkeley, CA 94710

916-772-5800 1310 Blue Oaks Blvd Suite 400 Roseville, CA, 95678


# East Side Education Cente

Date: 2/16/2017

Calcs by: Cain Boulden
Voice: (510) 499-9313
cainb@ltgsys.com

Page 1 of 1

This report attempts to approximate the maintained light levels and is based on the information provided to Lighting Systems. Please verify data to ensure accuracy of the report. Many factors that can affect field-measured lighting levels cannot be anticipated in the calculation and as such Lighting Systems cannot warranty lighting levels.

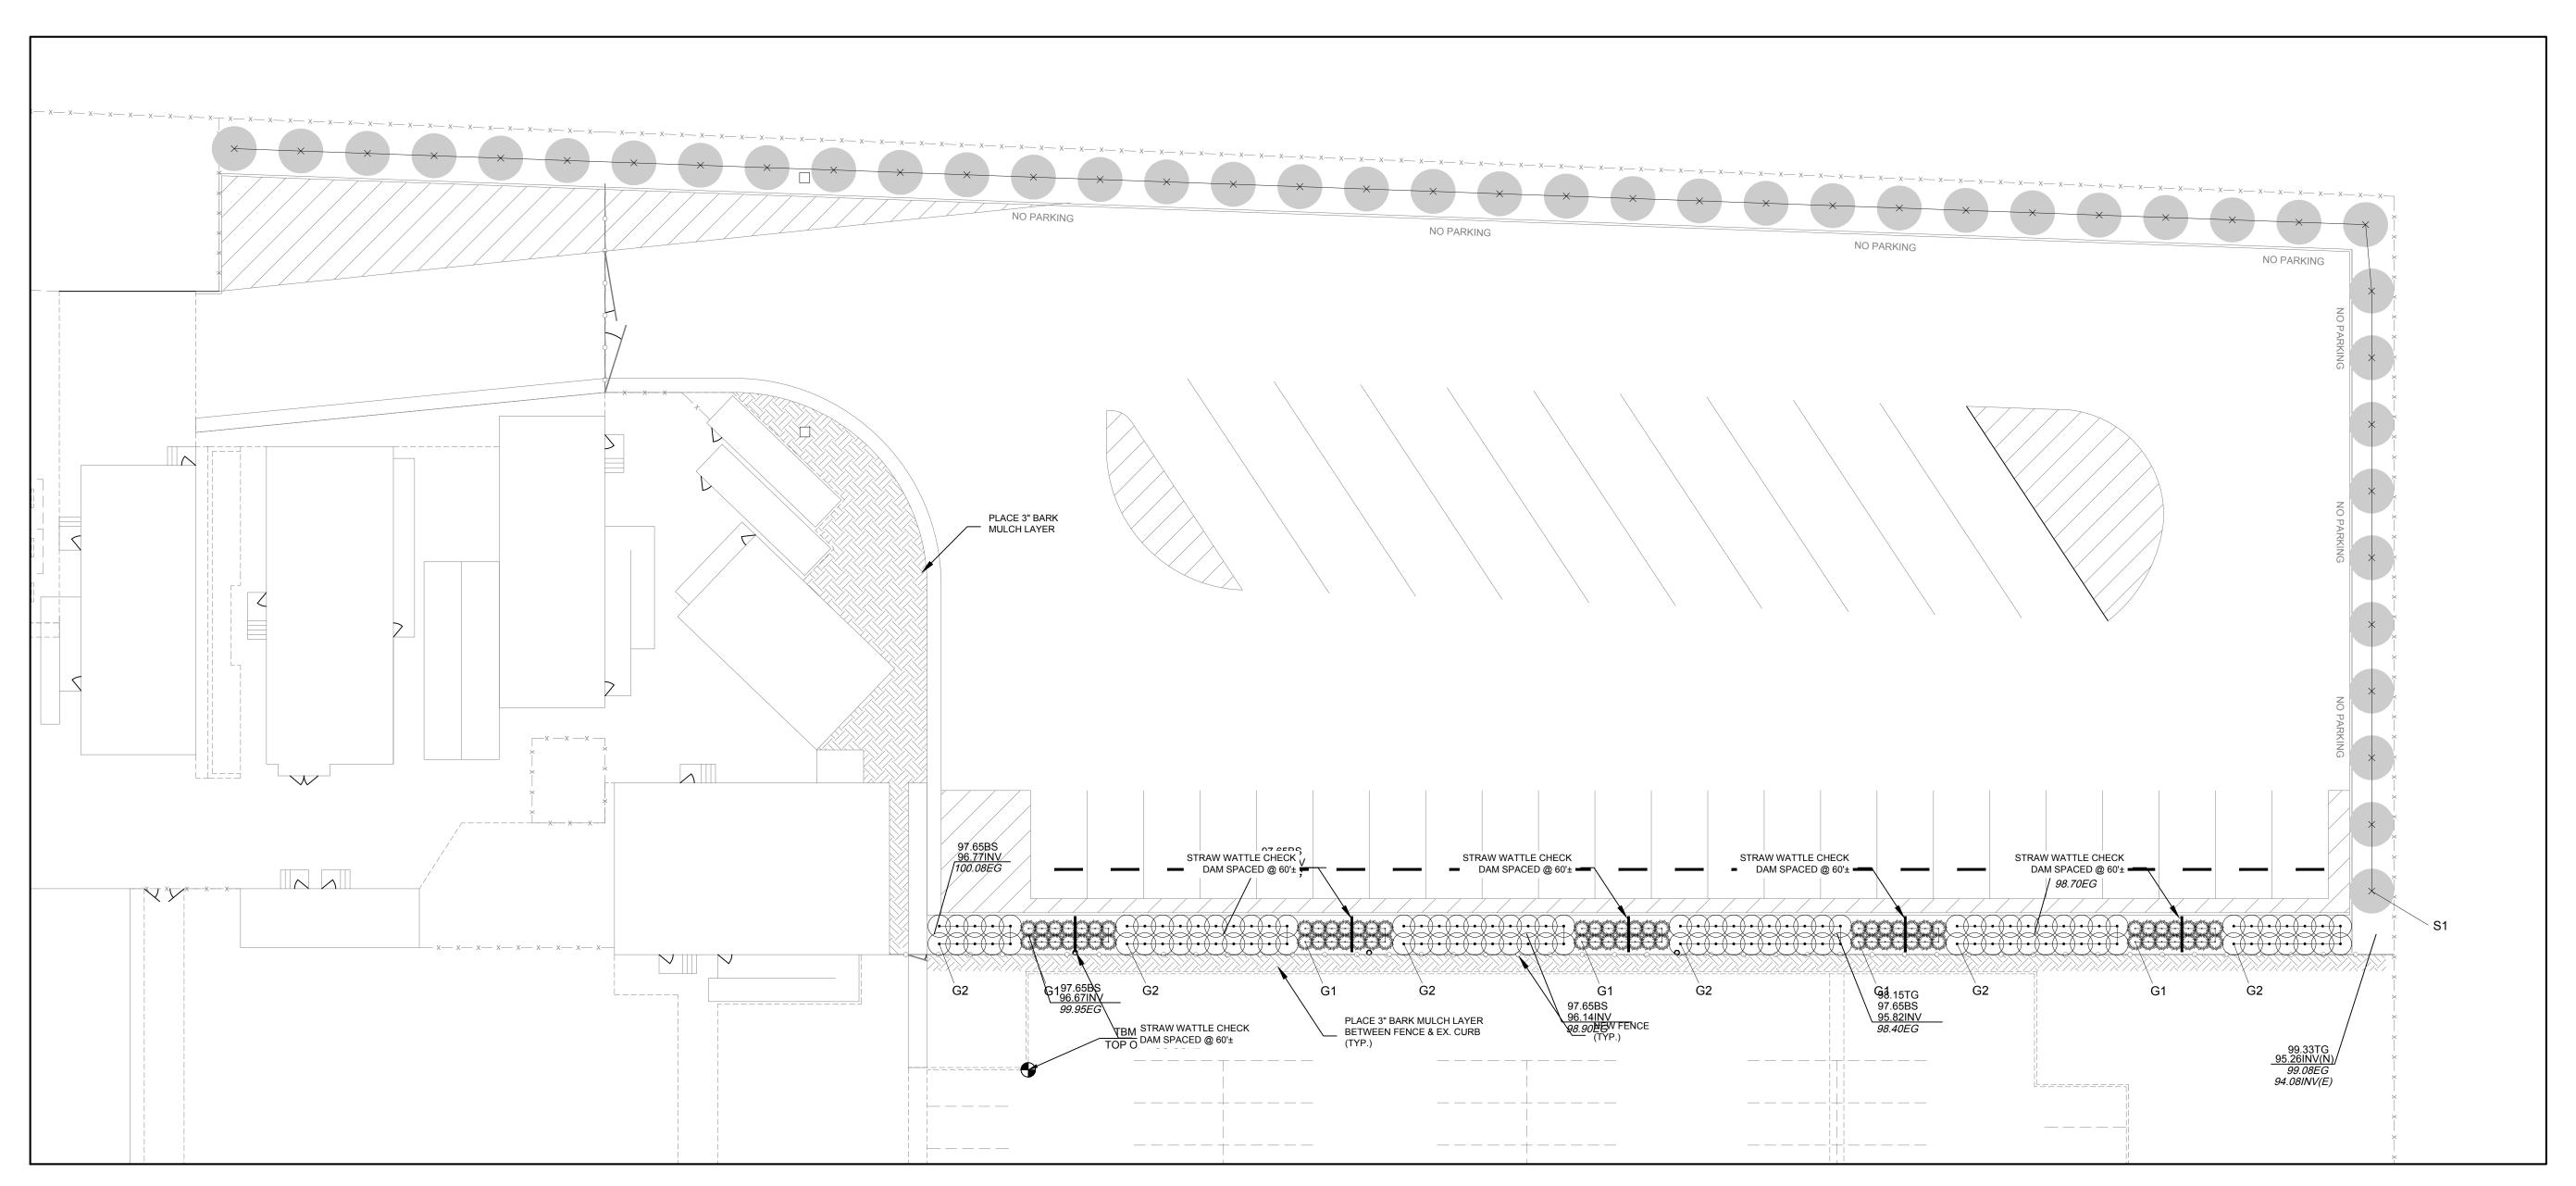


PLANT LEGEND									
SYMBOL	QTY.	SIZE	BOTANICAL NAME / COMMON NAME	SPACING / NOTES					
S1	43	15	Juniperus c. 'Kaizuka' / Hollywood Juniper	Spaced @ 15' o.c. max.					
G1	70	1	Panicum virgatum / Switchgrass	Spaced @ 30" o.c. max.					
G2	104	1	Cotoneaster d. 'Lowfast' / Bearberry Cotoneaster	Spaced @ 48" o.c. max.					

### PLANTING NOTES:

- 1. PLANT COUNT SHOWN IS FOR THE CONVENIENCE OF THE CONTRACTOR AND DOES NOT NECESSARILY INDICATE THE EXACT AMOUNTS REQUIRED TO EXECUTE THE LANDSCAPE PLAN. THE CONTRACTOR SHALL BE RESPONSIBLE FOR THE EXECUTION OF THE PLAN AS DRAWN. ANY DISCREPANCIES SHALL BE BROUGHT TO THE ATTENTION OF THE OWNER'S REPRESENTATIVE PRIOR TO THE BID.
- 2. ALL NEW LANDSCAPED AREAS, & THOSE AREAS SHOWN ON THE PLANTING PLAN, TO BE TOP-DRESSED WITH A 3" LAYER OF SHREDDED BARK MULCH. NO PLASTIC OR IMPERMEABLE SURAFCING SHALL BE ALLOWED BENEATH MULCH.
- 3. INSTALL GROUNDCOVER PLANTS NO CLOSER THAN 30" FROM EDGE OF PLANTER AREA.
- 4. BIOSWALE PLANTING MIX: HYDROPHOLIC PLANT MIX PER SANTA CLARA VALLEY URBAN POLLUTION PROGRAM GUIDELINES. AVOID COMPACTION DURING & POST-CONSTRUCTION. PLACE SOIL IN 12" MAX. LIFTS, WET TO CONSOLIDATE. DO NOT MECHANICALLY TAMP OR COMPACT SOILS DURING INSTALLATION.
- 5. PRIOR TO ANY PLANTING OR IRRIGATION WORK, CONTRACTOR SHALL ENSURE THAT ALL LIME--TREATED SOIL HAS BEEN REMOVED FROM PLANTER AREAS. CONTRACTOR SHALL COORDINATE W/OWNER'S REPRESENTATIVE TO TEST FOR LIME IN PLANTER AREAS PRIOR TO COMMENCING LANDSCAPING WORK.
- 6. SOILS IN ALL NEW PLANTER AREAS (EXCEPT WHERE SPECIFICALLY INDICATED FOR BIOSWALE PLANTING MIX) SHALL INCORPORATE COMPOST AT A RATE OF AT LEAST 4 CY PER 1,000 SF TO A DEPTH OF SIX INCHES (UNLESS CONTRAINDICATED BY A SOILS FERTILITY TEST).

# PLANTING IMPROVEMENTS 1" = 20'

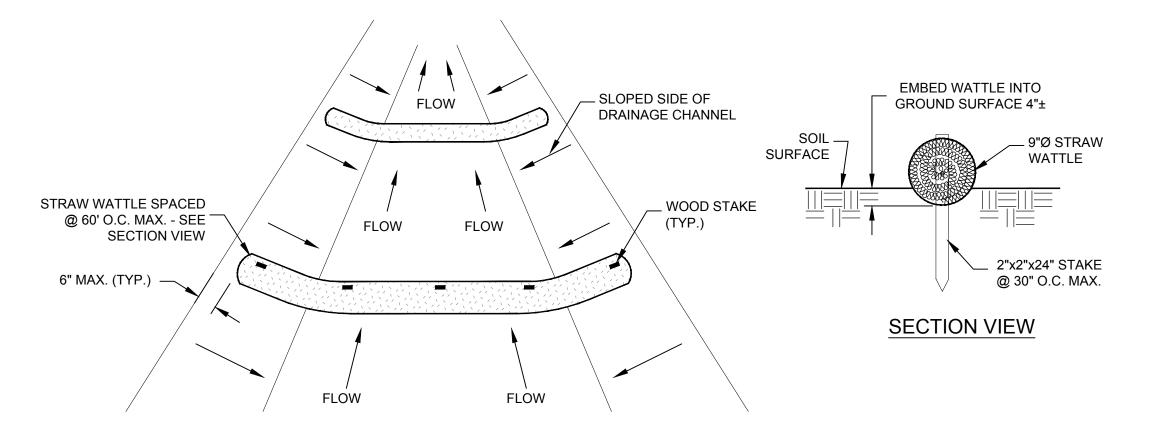

STRAW WATTLE CHECK DAM INSTALLATION

San Luis Obispo, CA 93401-6015

You can ride on our reputation
Corporate Office:
3485 Sacramento Drive, Suite A
San Luis Obispo, CA 93401-6015
805-781-2265

SAN JOSE, CA

SIDE UNION HIGH SCAPITOL AVENUE
RANSPORTATION YARD R

830 N. CAPITOL

DRAWN BY:

MPW

PROJECT NUMBER:

160290


SCALE:

1"= 20'

DATE:

JAN. 2017

SHEET NUMBER:

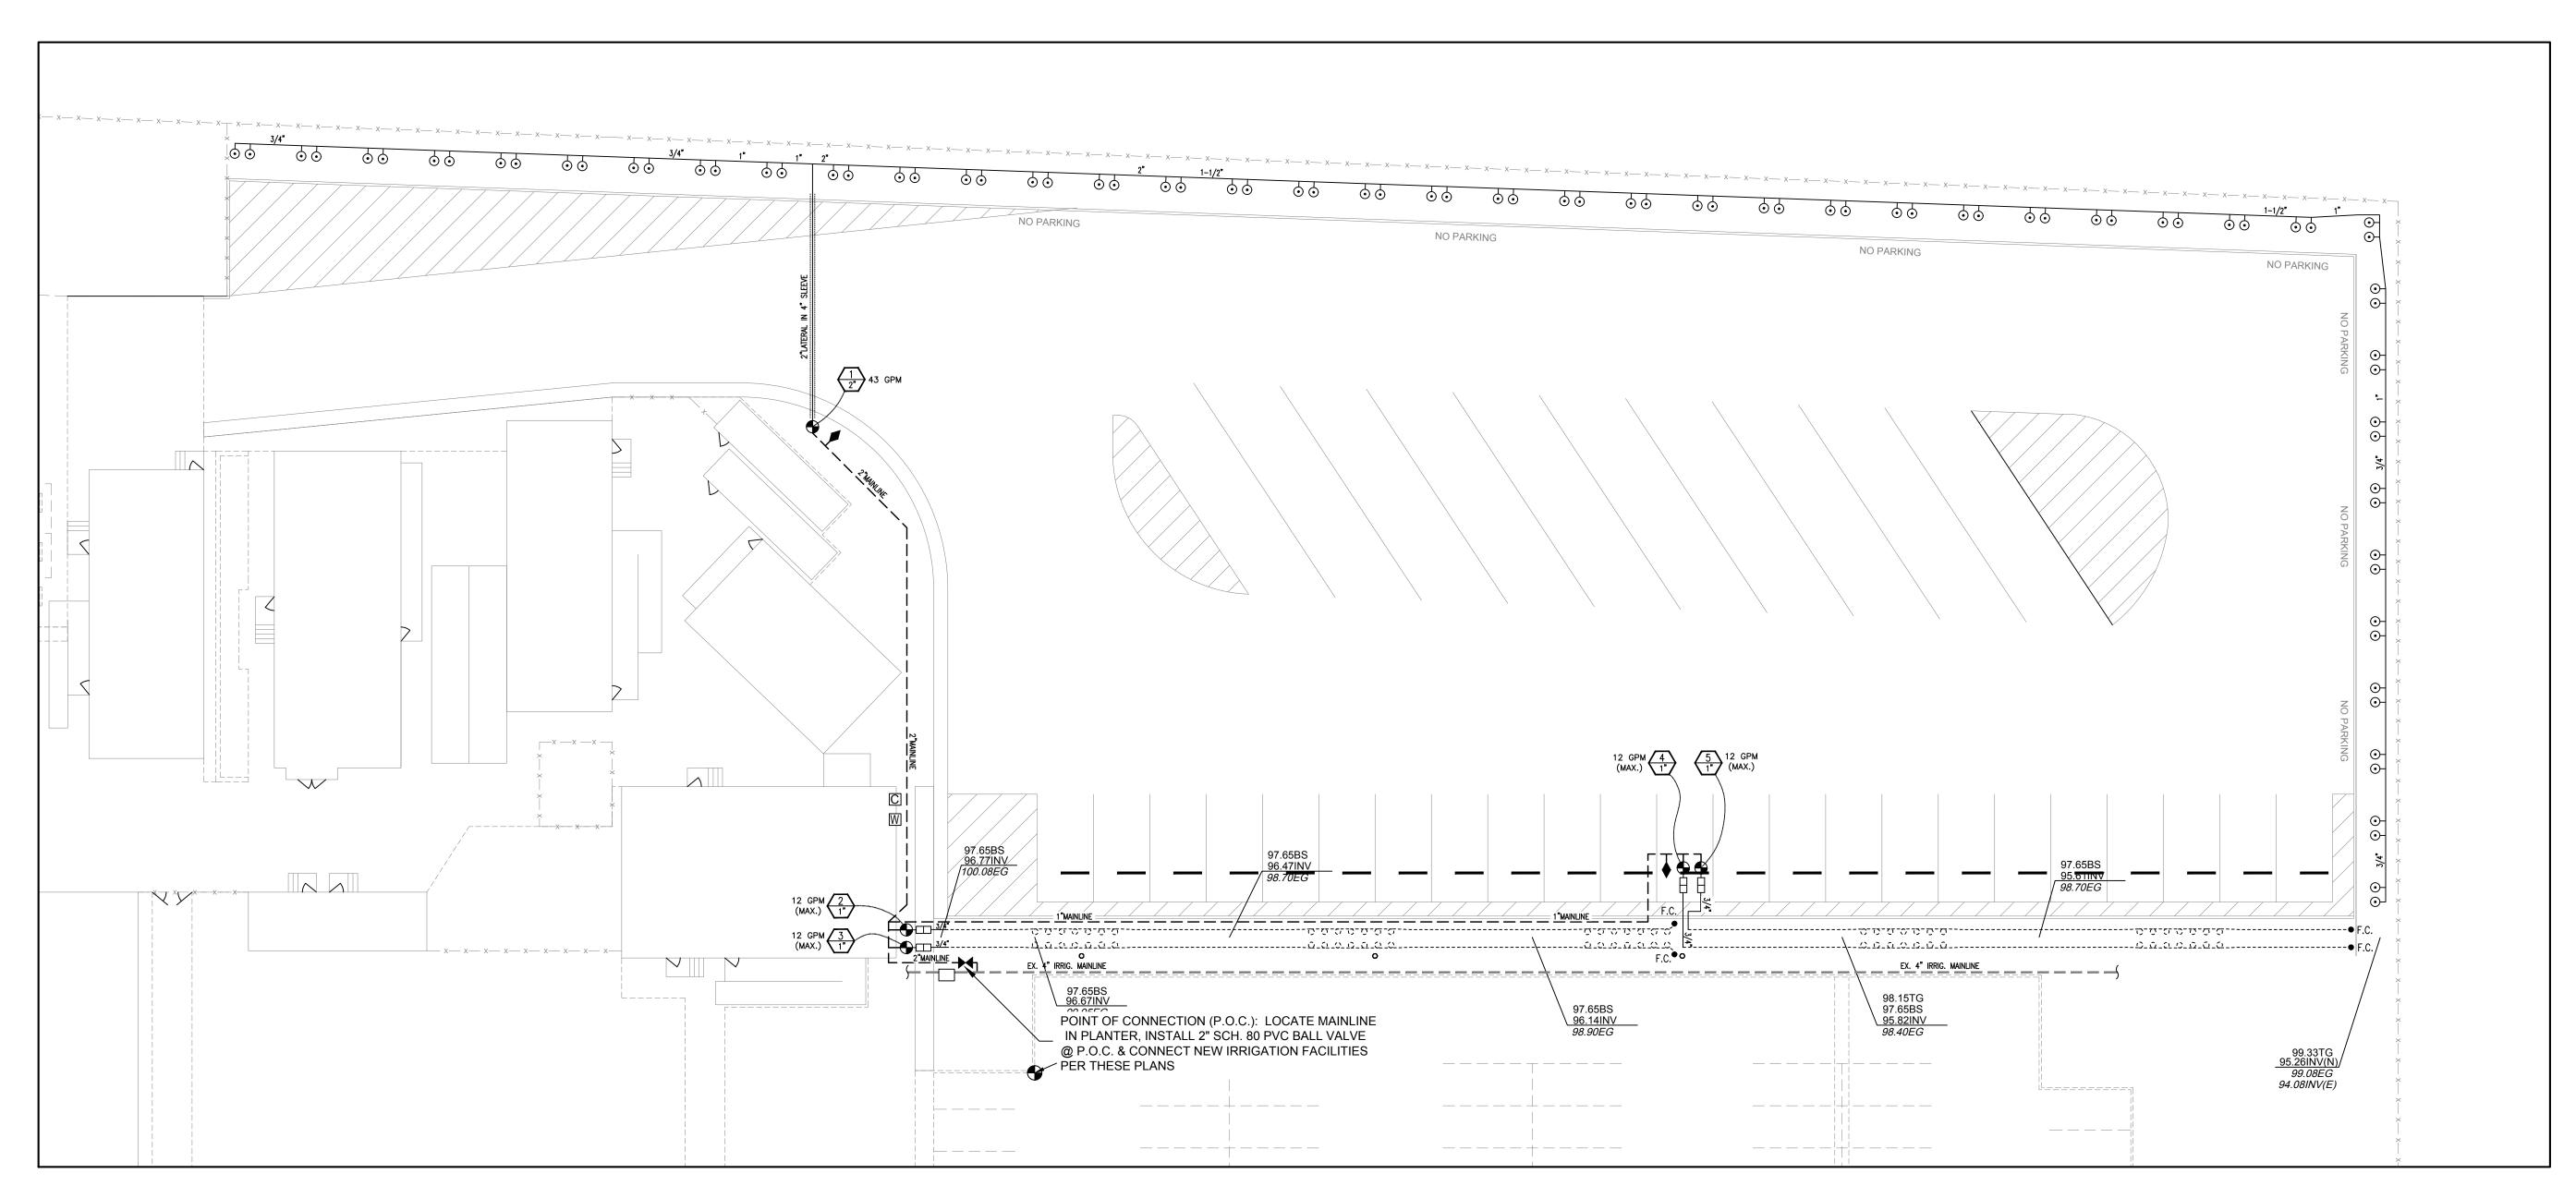

# IRRIGATION IMPROVEMENTS

SYM	MODEL	DESCRIPTION
<u> </u>	RWS-B-C-1402	RAINBIRD DEEP ROOT WATERING SYSTEM (W/BUBBLER) - 1/2 GPM
•	PEB SERIES VALVE	RAINBIRD REMOTE CONTROL VALVE (SIZE PER PLAN)
$\overline{\wedge}$	VALVE NO.	
$\Box$	VALVE SIZE	
С	PC-300	HUNTER PC-300 (OUTDOOR) IRRIGATION CONTROLLER (SEE NOTE 4)
W	WR2	RAINBIRD WR2-RC WIRELESS RAIN SENSOR (SEE NOTE 5)
•	44-RC	RAINBIRD QUICK COUPLER, 1"
		SCHEDULE 80 PVC MAINLINE - SIZES SHOWN
		SCHEDULE 40 PVC LATERAL - SIZES SHOWN
		NETAFIM TECHLINE TLDL6-12 (SEE TECHLINE NOTES)
Ш	PMR-MF	3/4" SENNINGER PRESSURE REGULATOR
	TF-075	3/4" NETAFIM TECH FILTER (SEE TECHLINE NOTES)
F.C.●	TLFV-1	NETAFIM FLUSHING END CAP

### **IRRIGATION NOTES:**

- 1. ALL IRRIGATION FOR THIS SITE WILL BE ACCOMPLISHED WITH LOW-FLOW BUBBLERS SET BELOW GRADE IN PERFORATED TUBING & DRIP-LINE BY NETAFIM. NO SPRINKLER OR ROTOR SYSTEMS WILL BE UTILIZED.
- 2. IN SOME INSTANCES IRRIGATION COMPONENTS ARE SHOWN OUTSIDE OF LANDSCAPE OR PLANTER AREAS FOR THE SAKE OF CLARITY. INSTALL ALL VALVES IN LANDSCAPE AREAS. INSTALL IRRIGATION LATERALS AND MAINLINE IN LANDSCAPE AREAS WHENEVER POSSIBLE.
- 3. ALL IRRIGATION PIPE UNDER HARDSCAPE SURFACES SHALL BE INSTALLED IN SLEEVES. AS A MINIMUM SLEEVE SHALL BE AT LEAST 2 PIPE SIZES LARGER THAN IRRIGATION LINE (IF NOT OTHERWISE SPECIFIED ON PLANS).
- 4. NEW RAINBIRD IRRIGATION CONTROLLER TO BE MOUNTED ON EXTERIOR WALL OF BUILDING (FINAL LOCATION BY OWNER). COORDINATE W/ELECTRICAL FOR POWER TO CONTROLLER.
- 5. INSTALL RAINBIRD WIRELESS RAIN SENSOR ON BUILDING (FINAL LOCATION BY OWNER) PER MANUFACTURER'S RECOMMENDATIONS.
- 6. ALL NEW IRRIGATION VALVES TO HAVE CHRISTY STANDARD SIZE I.D. TAGS.

### TECHLINE NOTES:

- 1. 3/4" SENNINGER PRESSURE REGULATOR AND 3/4" NETAFIM TECH-FILTER TO BE INSTALLED TOGETHER IN A JUMBO VALVE BOX.
- 2. BURY NETAFIM TECHLINE 2" DEEP IN ALL PLANTER AREAS. PIN TUBING EVERY 5' MAX. TECHLINE PLACEMENT AS SHOWN ON THE DRAWINGS IS SCHEMATIC ONLY -SEE TECHLINE INSTALLATION DETAILS FOR PLACEMENT AROUND PLANT MATERIAL.
- 3. EACH TERMINATION POINT OF TECHLINE SHALL HAVE A NETAFIM FLUSHING END CAP INSTALLED IN A 7" ROUND LANDSCAPING BOX FOR EASY ACCESS.

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SCHOOL

N YARD RELOCATION PARA PROVEMENT PL

UNION HIGH 830 N. CAPITOL AVENUE
2017 TRANSPORTATION Y
IRRIGATION IMP SIDE

MPW 160290 1"= 20'

JAN. 2017

**L2**